MONTGOMERY COUNTY DEPARTMENT OF TRANSPORTATION

BOYDS TRANSIT IMPROVEMENTS

C. I. P. PROJECT 509337

ALL REQUIRED PERMITS PRIOR TO ISSUANCE OF APPROVED SEDIMENT CONTROL PERMIT:					
TYPE OF PERMIT	REQD	NOT REQD	PERMIT NO.	EXPIRATION DATE	WORK RESTRICTION DATES
M.C.D.E.P. Floodplain District		X			
WATERWAY/WETLANDS					
a. Corps of Engineers		X			
b. M.D.E.		X			
c. M.D.E. Water Quality Certification		X			
M.D.E. Dam Safety		Х			
DNR Roadside Tree Care Permit		X			
DPS Roadside Tree Protection Plan		Х			
N.P.D.E.S. NOTICE OF INTENT	X				
M.C.D.P.S. STORMWATER MANAGEMENT	Х				
M.C.D.P.S. SEDIMENT CONTROL	Х				

DEVELOPER'S/BUILDER'S CERTIFICATION

I HEREBY CERTIFY THAT ALL CLEARING, GRADING, CONSTRUCTION AND/OR DEVELOPMENT WILL BE DONE PURSUANT TO THIS PLAN AND THAT ANY RESPONSIBLE PERSONNEL INVOLVED IN THE CONSTRUCTION PROJECT WILL HAVE A CERTIFICATE OF ATTENDANCE OF A DEPARTMENT OF NATURAL RESOURCES APPROVED TRAINING PROGRAM FOR THE CONTROL OF SEDIMENT AND EROSION BEFORE BEGINNING

$D \wedge T \Gamma$		
11//11		
1/411		

TIM CUPPLES, P.E., CHIEF DIVISION OF TRANSPORTATION ENGINEERING

DESIGN CERTIFICATION

I HEREBY CERTIFY THAT THIS PLAN HAS BEEN PREPARED IN ACCORDANCE WITH THE "2011 MARYLAND STANDARDS AND SPECIFICATIONS FOR SOIL EROSION AND SEDIMENT CONTROL", MONTGOMERY COUNTY DEPARTMENT OF PERMITTING SERVICES EXECUTIVE REGULATIONS 5-90, 7-02AM AND 36-90, AND MONTGOMERY COUNTY DEPARTMENT OF PUBLIC WORKS AND TRANSPORTATION "STORM DRAIN DESIGN CRITERIA" DATED JUNE, 2014.

DVIE	
DAIL	

PAMELA H. DESTINO, P.E. MD REGISTRATION NO. 42708

CERTIFICATION OF QUANTITIES

I FURTHER CERTIFY THAT THE TOTAL AMOUNTS OF EXCAVATION AND FILL AS SHOWN ON THESE PLANS HAVE BEEN COMPUTED TO BE 2,700 CUBIC YARDS OF EXCAVATION AND 90 CUBIC YARDS OF FILL AND THAT THE TOTAL AREA TO BE DISTURBED AS SHOWN ON THESE PLANS HAS BEEN DETERMINED TO BE A MAXIMUM OF 33,358 SQUARE FEET OR 0.77 ACRES.

TREE CANOPY REQUESTION To be completed by the consultant and placed on the first splan set for a	sheet of the Sediment Control / Stormwater Management
Exempt: Yes No If exempt under S applicable exemption category below.	ection 55-5 of the Code, please check the
Total Property Area	Total Disturbed Area
square feet	square feet
Shade Trees Required	Shade Trees Proposed to be Planted
Fee in Lieu	
(Trees Required – Trees Planted) x \$250	\$
Required Number	of Shade Trees
Area (sq. ft.) of the Limits of Disturbance	Number of Shade Trees Required
FROM TO 1 6,000 6,001 8,000 8,001 12,000 12,001 14,000	3 6 9 12

If the square footage of the limits of disturbance is more than 40,000, then the

EXEMPTION CATEGORIES:

55-5(h) any stream restoration project if the

55-5(i) cutting or clearing any tree to comply with

applicable provisions of any federal, state, or local law

OTHER: Specify per Section 55-5 of the Code.

erson performing the work has obtained all

overning safety of dams;

number of shade trees required must be calculated using the following formula:

(Number of Square Feet in Limits of Disturbance $\div 40,000$) × 15

55-5(a) any activity that is subject to Article II of

arvesting operation with an approved exemption fro

55-5(f) any activity conducted by the County Par

55-5(g) routine or emergency maintenance of an


existing stormwater management facility, including ar

existing access road, if the person performing the

55-5(b) any commercial logging or timber

Article II of Chapter 22A;

PAMELA H. DESTINO, P.E. MD REGISTRATION NO. 42708

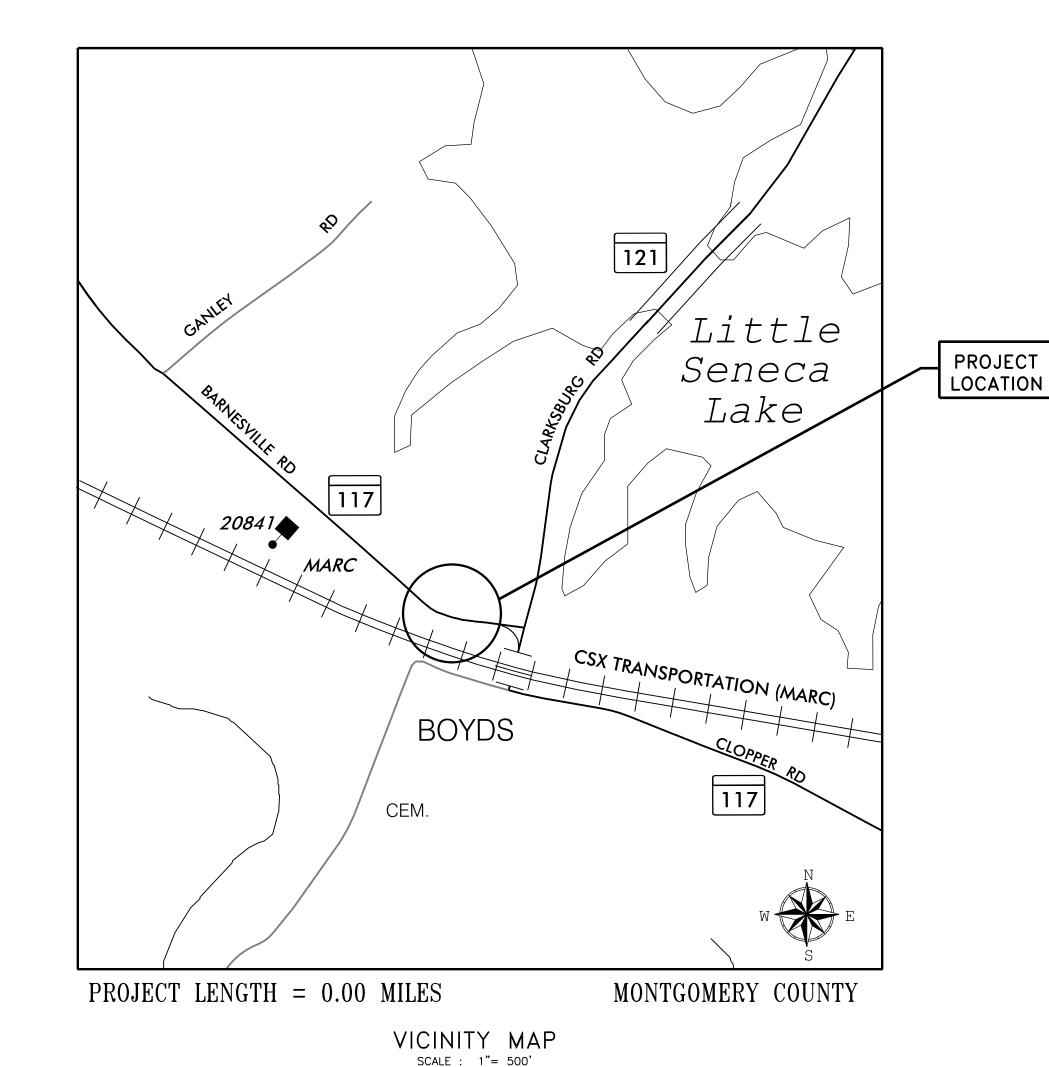

GENERAL NOTES

- 1. THE SPECIFICATIONS FOR THIS CONTRACT WILL BE THOSE OF THE MARYLAND STATE HIGHWAY ADMINISTRATION DATED JULY 2008, ALL ERRATA AND ADDENDA THERETO. THE MARYLAND STATE HIGHWAY ADMINISTRATION BOOK OF STANDARDS FOR HIGHWAY AND INCIDENTAL STRUCTURES, WASHINGTON SUBURBAN SANITARY COMMISSION (W.S.S.C.) STANDARDS, MONTGOMERY COUNTY DEPARTMENT OF TRANSPORTATION STANDARDS, AND SOIL CONSERVATION SERVICE POND CONSTRUCTION SPECIFICATIONS FOR MARYLAND.
- 2. HORIZONTAL DATUM: NAD 83(1991) VERTICAL DATUM: NAVD 88.
- 3. TYPES OF STORM DRAIN STRUCTURES REFER TO THE "DESIGN STANDARDS" OF MONTGOMERY COUNTY DEPARTMENT OF TRANSPORTATION, UNLESS OTHERWISE NOTED.
- 4. WHEN THE DROP ON THE MAIN LINE THROUGH A STORM DRAIN STRUCTURE CAN BE ACCOMMODATED BY AN INVERT SLOPE OF 1.5:1 OR FLATTER, A ROUNDED CHANNEL LINED WITH SEWER BRICK ON EDGE SHALL BE BUILT TO THE CROWN OF THE PIPES. WHEN THE INVERT SLOPES WOULD BE GREATER THAN 1.5:1 A SPECIAL INVERT SHALL BE CONSTRUCTED AS NOTED.
- 5. ALL STORM DRAIN PIPE SHALL BE INSTALLED WITH CLASS "C" BEDDING UNLESS OTHERWISE SPECIFIED.
- 6. THE CONTRACTOR SHALL MAKE FIELD ADJUSTMENTS TO STORM DRAIN STRUCTURES, WHEN NECESSARY, TO MEET EXISTING CONDITIONS, AS APPROVED BY MONTGOMERY COUNTY DEPARTMENT OF TRANSPORTATION'S PROJECT INSPECTOR.
- 7. INFORMATION CONCERNING UNDERGROUND UTILITIES WAS OBTAINED FROM AVAILABLE RECORDS, BUT THE CONTRACTOR MUST DETERMINE THE EXACT LOCATIONS AND ELEVATIONS OF THE LINES BY DIGGING TEST PITS BY HAND AT ALL UTILITY CROSSINGS, WELL IN ADVANCE OF TRENCHING. IF CLEARANCES ARE LESS THAN SHOWN OR SIX (6) INCHES, WHICHEVER IS LESS, CONTACT MONTGOMERY COUNTY DEPARTMENT OF TRANSPORTATION'S PROJECT INSPECTOR AND THE APPROPRIATE UTILITY OWNER BEFORE PROCEEDING WITH CONSTRUCTION.
- 8. REPAIRS TO UTILITIES OR PROPERTY DAMAGE AS A RESULT OF THE CONTRACTOR'S NEGLIGENCE OR METHOD OF OPERATION MUST BE MADE AT THE CONTRACTOR'S EXPENSE BEFORE PROCEEDING WITH CONSTRUCTION.
- 9. CLEARING IS TO BE LIMITED TO THE "LIMIT OF GRADING" AS SHOWN ON THE PLANS.

10. ALL GRADING SHALL BE DONE IN SUCH A MANNER AS TO PROVIDE POSITIVE DRAINAGE.

- 11. DISTURBED AREAS ADJACENT TO ESTABLISHED LAWNS SHALL BE SODDED. OTHER DISTURBED AREAS SHALL BE SEEDED AND MULCHED.
- 12. THE CONTRACTOR SHALL OBTAIN A ROADSIDE TREE PERMIT FOR ANY MAINTENANCE, TREATMENT, PLANTING, REMOVAL, OR ROOT CUTTING ON TREES WITHIN THE PUBLIC RIGHT OF WAY. PERMIT REQUIREMENTS MAY BE OBTAINED FROM THE DEPARTMENT OF NATURAL RESOURCES. MARYLAND FOREST. PARK AND WILDLIFE SERVICE, TELEPHONE 301-854-6060.
- 13. CONTACT THE WASHINGTON SUBURBAN SANITARY COMMISSION SYSTEM MAINTENANCE ENGINEER BEFORE EXCAVATING BENEATH OR IN THE VICINITY OF EXISTING WATER OR SEWER LINES. BACKFILL TO BE DONE UNDER SUPERVISION OF CALL 301-206-9772
- 14. ALL UTILITY POLES NOTED FOR RELOCATION SHALL BE PERFORMED BY OTHERS.
- 15. PRIOR TO VEGETATIVE STABILIZATION, ALL DISTURBED AREAS MUST BE TOPSOILED PER THE MONTGOMERY COUNTY "STANDARDS AND SPECIFICATIONS FOR TOPSOIL".
- 16. CALL "MISS UTILITY" AT 1-800-257-7777 48 HOURS PRIOR TO THE START OF WORK. THE EXCAVATOR MUST NOTIFY ALL PUBLIC UTILITY COMPANIES WITH UNDERGROUND FACILITIES IN THE AREA OF PROPOSED EXCAVATION AND HAVE THOSE FACILITIES LOCATED BY UTILITY COMPANIES PRIOR TO COMMENCING EXCAVATION. THE EXCAVATOR IS RESPONSIBLE FOR COMPLIANCE WITH REQUIREMENTS OF CHAPTER 36A OF THE MONTGOMERY COUNTY CODE.

MONTGOMERY COUNTY DEPARTMENT OF PERMITTING SERVICES APPROVED FOR:

STORMWATER MANAGEMENT

SEDIMENT CONTROL TECHNICAL REQUIREMENTS

: NTS

OWNER/ADDRESS:
MONTGOMERY COUNTY
DEPARTMENT OF TRANSPORTATION
100 EDISON PARK DRIVE, 4TH FLOOR
GAITHERSBURG, MD 20878

REBECCA PARK, P.E. 240-777-7263

PROFESSIONAL CERTIFICATION. I HEREBY CERTIFY THAT THESE DOCUMENTS WERE PREPARED OR APPROVED BY ME, AND THAT I AM A DULY LICENSED PROFESSIONAL ENGINEER UNDER THE LAWS OF THE STATE OF MARYLAND, LICENSE NO. EXPIRATION DATE:_

			ı
			L
WRA			
			L
Whitman, Requardt & Associates, LLP			L
801 South Caroline Street, Baltimore, Maryland 21231			
	NO.	REVISION	ĺ

	S.M. FILE NO).	
DEPARTMENT OF	RY COUNTY TRANSPORTATIO G, MARYLAND)N	
RECOMMENDED FOR APPROVAL			
Chief, Transportation Planning and Design Ser APPROVED	ction	Date	
Chief, Division of Transportation Engineering		Date	SCALE
Designed by: PHD Drawn by: _	JDG Checked	by:JAG	Project

Approved

TI-01 TITLE SHEET

BOYDS TRANSIT IMPROVEMENTS

JUNE 2019 Project No. : <u>509337</u> SHEET ____1 of ___9

MCDPS-SC/SWM SHEET NO. 1 OF 9

NOTE: MCDPS APPROVAL DOES NOT NEGATE THE NEED FOR A

MCDPS ACCESS PERMIT.

ADMINISTRATIVE REQUIREMENTS

MCDPS APPROVAL OF THIS PLAN WILL EXPIRE ONE YEAR FROM THE DATE OF APPROVAL IF THE PROJECT HAS NOT STARTED UNLESS THE PERMIT HAS BEEN EXTENDED

INDEX OF SHEETS

SHEET NO.	DRAWING DESCRIPTION
1	TITLE SHEET
2	INDEX OF SHEETS, LEGEND, AND ABBREVIATIONS
3	GS-01 - GEOMETRIC LAYOUT SHEET
4	HT-01 - TYPICAL SECTIONS
5	PD-01 - PAVEMENT DETAILS
6	HD-01 - ROADWAY PLAN
7	HP-01 - ROADWAY PROFILE
8	GR-01 - SITE GRADING PLAN
9	SN-2.01 - SIGNING AND MARKING PLAN


LEGEND

(T)	TELEPHONE MANHOLE		
(WM)	WATER METER	O	EXISTING WBEAM
\bowtie	WATER VALVE	<u> </u>	PROPOSED WBEAM
		WB	WETLAND BUFFER
(SS)	SEWER MANHOLE		WETLAND
(D)	STORM DRAIN MANHOLE	- x x -	PROPOSED FENCE
Ġ	GAS VALVE	-× ×	EXISTING CHAINLINK FENCE
© ⊙	SIGN	^ ^	
*	LIGHT POLE		INDEX CONTOUR
Ø	UTILITY POLE	— — 300 — -	INTERVAL CONTOUR
\searrow	FIRE HYDRANT	<u> — с — </u>	TOP OF CUT
		⊢— F —— ⊣	TOE OF FILL
	PARKING METER		EXISTING RIGHT OF WAY LINE
	TREE	—— LOD ——	LIMIT OF DISTURBANCE
	BORING	TCE	TEMPORARY CONSTRUCTION EASEMEN
	INLET		
MH	MANHOLE	— — PE — —	PERPETUAL EASEMENT

ABBREVIATIONS

A.A.S.H.T.O	American Association of State Highway	LPL	ow Point
	Transportation OfficialsApproximate	LTL	
APPROX	Approximate	MAX,	Maximum.
B or B/L	Baseline	MOD	Modified
C.C	Center of Curve	MIN	<i>l</i> linimum
C or C/L	Centerline	N	lorth (
C.I.P	Cast Iron Pipe	NB	Northbound Technology (1984)
C.M.P	Corrugated Metal Pipe	NE	lortheast Table 1
C.O	Cleanout	NTS	lot To Scale
COMB	Combination	O.CC	
CONC	Concrete	P.CF	Point of Curvature
CONSTR	Construction	P.C.C F	oint of Compound Curve
C.P.P	Corrugated Polyethylene Pipe	P/CF	Point of Compound Curve Point of Crown
D.B.H	Diameter Breast Height	P/GEF	Profile Grade Elevation
DC	Degree of Curve	P.G.F	Profile Ground Elevation
D.H.V	Design Hourly Volume		Profile Grade Line
D.I	Drop Inlet		Profile Ground Line
DIA	Diameter		Point of Rotation
D.O.	Double Opening	P.I. F	Point of Intersection
F	Double Opening East	P O C F	Point on Curve
F	Flectric		Point on Tangent.
F	Electric External Distance	PROP F	roposed
EA	Fach	PT	Point
F R	Eastbound.	PT	Point of Tangency
ELEV	Flevation	PVC	Point of Vertical Curve
FRCCP	Elliptical Reinforced Cement	PVC F	Polyvinyl Chloride
L.IV.O.O.I	Concrete Pine	P\/I	Point of Intersection
FS	Concrete Pipe End Section	RF	
EX. or EXIST	Frietina	RET. WALLF	
FT	Foot	RT F	Retaining wan
F or FL	Flowling	RW or R/WF	Right of Way
FWD	Forward	P C P	Reinforced Cement Pipe
G		P C C P	Reinforced Cement Tipe Reinforced Cement Concrete Pipe
	Horizontal Elliptical Reinforced	SS	South
11.L.IN.C.F			
ПD	Concrete Pipe		Superpave Asphalt Mix
	High Point	SBS S.DS	
	Hot Mix Asphalt		
HT		S.ES	
IN		SFS	
INV		S.F	· ·
L			Sanitary Sewer
LAND2C	Landscaped	22D	Stopping Sight Distance
L.F	Linear Feet	55t	Super Silt Fence
		STDS	otanaara

DRAINAGE STRUCTURE STAKEOUT LOCATION

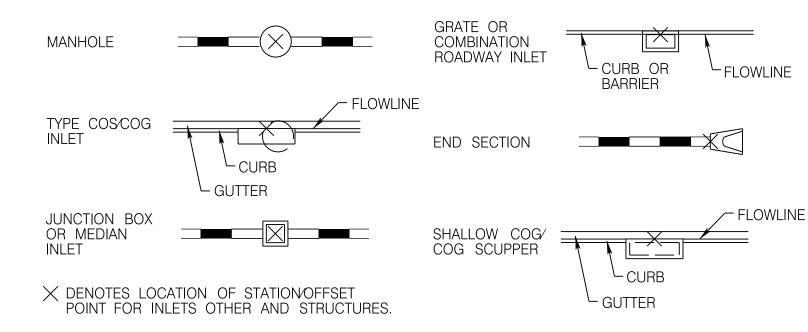

T.C DENOTES TOP OF COVER

T.G DENOTES TOP OF GRATE

DRAINAGE BUBBLES

(SAIVIPLES)	
INLET	
MANHOLE	MH 1
JUNCTION BOX	JB 1
FIELD CONNECTION	C
BEND	B 1
END SECTION	ES 1
END WALL	EW 1
ADJUST EX. STRUCTURE	$\begin{pmatrix} A \\ 1 \end{pmatrix}$

MCDPS-SC/SWM SHEET NO. 2 OF 9

...Station _

Sidewalk

Tangent

..Typical

..Variés

₋Water

. West

T.C.P.

U.P.

VAR.

WB..

Telephone

..Útiٰlity Pole

...Westbound

Single Opening
Square Yards

...Terra Cotta Pipe

...Vertical Curve Length

.. Storm Water Management

					•		
MONTGOMERY COU PERMITTING SERVIO			=		NOTE: MCDPS APPRO NEGATE THE N MCDPS ACCES		
STORMWATER MANAGEME	IT	SEDIMENT CONTRO	l technical requir	REMENTS	ADMINISTRAT	IVE REQUIREMENTS	
ESDS AND WAIV	<u>ERS</u>						
Reviewed Date		Reviewed Approved	Date Date			Date XXXX ONTROL PERMIT NO.	_
Date					THE DATE OF APPROVAL II	PLAN WILL EXPIRE TWO YEA F THE PROJECT HAS NOT ST MIT HAS BEEN EXTENDED	

AGEMENT PLAN IS FOR DEMONSTRATED COMPLIANCE WITH MINIMUM ENVIRONMENTAL RUNOFF TREATMEN' IVERT OR CONCENTRATE RUNOFF ONTO ANY ADJACENT PROPERTY WITHOUT THAT PROPERTY OWNER'S DITHER RESPONSIBLE PERSON OF PROFESSIONAL LIABILITY OR ETHICAL RESPONSIBILITY FOR THE DOWNHILL PROPERTIES

PROFESSIONAL CERTIFICATION. I HEREBY CERTIFY THAT THESE DOCUMENTS WERE PREPARED OR APPROVED BY ME, AND THAT I AM A DULY LICENSED PROFESSIONAL ENGINEER UNDER THE LAWS OF THE STATE OF MARYLAND, LICENSE NO._ EXPIRATION DATE:_



			STANDARDS AND DOI PERMISSION. IT DOE:	A SEDIMENT CONTROL OR STORMWATI S NOT CREATE OR IMPLY ANY RIGH S NOT RELIEVE THE DESIGN ENGINEE DRAINAGE DESIGN AS IT AFFECTS UP	IT TO DIVERT OR CONCENTR ER OR OTHER RESPONSIBLE
			MONTGOMERY COUNTY DEPARTMENT OF TRANSPORTATION GAITHERSBURG, MARYLAND		
			RECOMMENDED FOR APPROVAL		
			Chief, Transportation Planning and Design Section APPROVED	Date	
			Chief, Division of Transportation Engineering	Date	SCALE : NTS
PEMISION	DATE	BV	Designed by: PHD Drawn by: JDG	Checked by: <u>JAG</u>	Project No. : _50

AND ABBREVIATIONS

BOYDS TRANSIT **IMPROVEMENTS**

INDEX OF SHEETS, LEGEND,

JUNE 2019 oject No. : <u>509337</u> SHEET <u>2</u> of <u>9</u>



PROFESSIONAL CERTIFICATION.



POE 30+84.92 BOYDS EXIT-A
POT 13+02.33 BARNESVILLE-B

 ${\sf MERI50}_{\Delta}$

 $\mathsf{MERI5I}_{\Delta}$

BOYDS EXIT-A


14+00 S82°19′48.78"W 15+00

701<u>∆</u> kci#6

700**△** kci#i

BARNESVILLE-B

CURVE

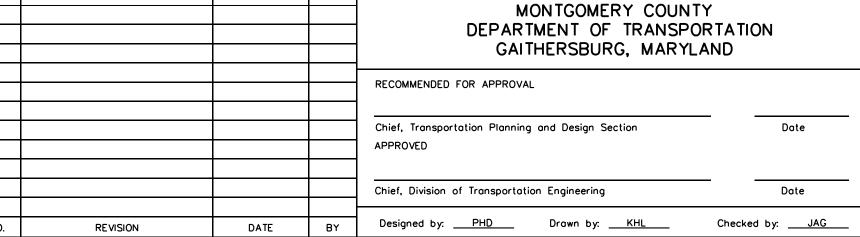

DELTA

GS-01 GEOMETRIC LAYOUT SHEET

JUNE 2019

SHEET _____3 of ____9

PI NORTH

PI EAST

SCALE : 1" = 50'

Project No. : 509337

CURVE DATA

BARNESVILLE-1|35°37' 53.36" LT | 16°02' 57.26" | 357.00' | 222.01' |114.73' 17.98' | 552,996.58 | 1,223,296.51

LINE DATA

BARNESVILLE-B 338.23' N 82° 19' 48.78" W

BOYDS ENT-A | 110.74' N 23° 46' 22.21" E

BOYDS EXIT-A 84.92' N 19° 31' 51.72" E

LENGTH

BEARING

N 46° 41' 55.42" W

Dc

LINE

BARNESVILLE-A 71.04'

BOYDS	TRANS
IMPROV	/EMENT

В	ROYDS	TRANS
1	MPROV	/EMENT

ROVED BY ME, AND	
SED PROFESSIONAL	
VS OF THE STATE	
0	Whit
	801 Sc

BARNESVILLE-

12+00

X-A

X-1

MERI53₄
POB 30+00.00

LEGEND

HORTIZONTAL LINE ID NUMBER

HORTIZONTAL CURVE ID NUMBER

BARNESVILLE-A

CONSTRUCTION CONTROL COORDINATES

B CONSTRUCTION MD 117 (BARNESVILLE ROAD)

₿ CONSTRUCTION BOYDS ENTRANCE

B CONSTRUCTION BOYDS EXIT

SURVEY CONTROL

MER150 552,912.07 1,223,526.45 418.17 MER151 552,820.98 1,223,484.05 422.28 MER152 552,937.51 1,223,419.19 431.62

KCI#6/701 552,913.13 1,223,578.80 413.62

EAST

1,223,769.59

1,223,277.12

1,223,334.61

1,223,244.72

1,223,486.78

1,223,712.71

POB STA. 10+00.00 | 553,123.98 |

BARNESVILLE-1 PT STA. 12+93.05 | 552,981.27 | 1,223,410.21

NORTH

553,075.26

POE STA. 16+31.29 | 552,936.12 | 1,223,745.42

POB STA. 20+00.00 | 552,923.92 | 1,223,235.83

POE STA. 21+10.74 553,025.26 1,223,280.47

POB STA. 30+00.00 552,899.99 1,223,391.02 POE STA. 30+84.92 | 552,980.03 | 1,223,419.41

| ELEVATION |

401.84

429.05

429.90

423.98

404.68

421.22

EAST

1,223,161.32

1,223,213.01

1,223,296.51

DESCRIPTION

3 | BARNESVILLE-1 | PI STA. 11+85.77 | 552,996.58

NORTH

MER100 | 552,913.78 |

MER101 553,004.33

MER153 552,935.49

MER154 552,884.43

|KCI#1/700| 552,988.68

KCI#5/712 552,788.42

POINT

CURVE

TRAVERSE

2 BARNESVILLE-1 PC STA. 10+71.04


POE 21+10.74 BOYDS ENT-A= POC 11+55.20 BARNESVILLE-I


POB 20+00.00

BOYDS ENT-A


		GAITHERSBURG, MARTLAND	
		RECOMMENDED FOR APPROVAL	
		Chief, Transportation Planning and Design Section APPROVED	Date
		Chief, Division of Transportation Engineering	Date

I HEKERA CEKIILA IHAI IHEZE DOCOMENIZ	
WERE PREPARED OR APPROVED BY ME, AND	
THAT I AM A DULY LICENSED PROFESSIONAL	
ENGINEER UNDER THE LAWS OF THE STATE	
OF MARYLAND, LICENSE NO	
EXPIRATION DATE:	8

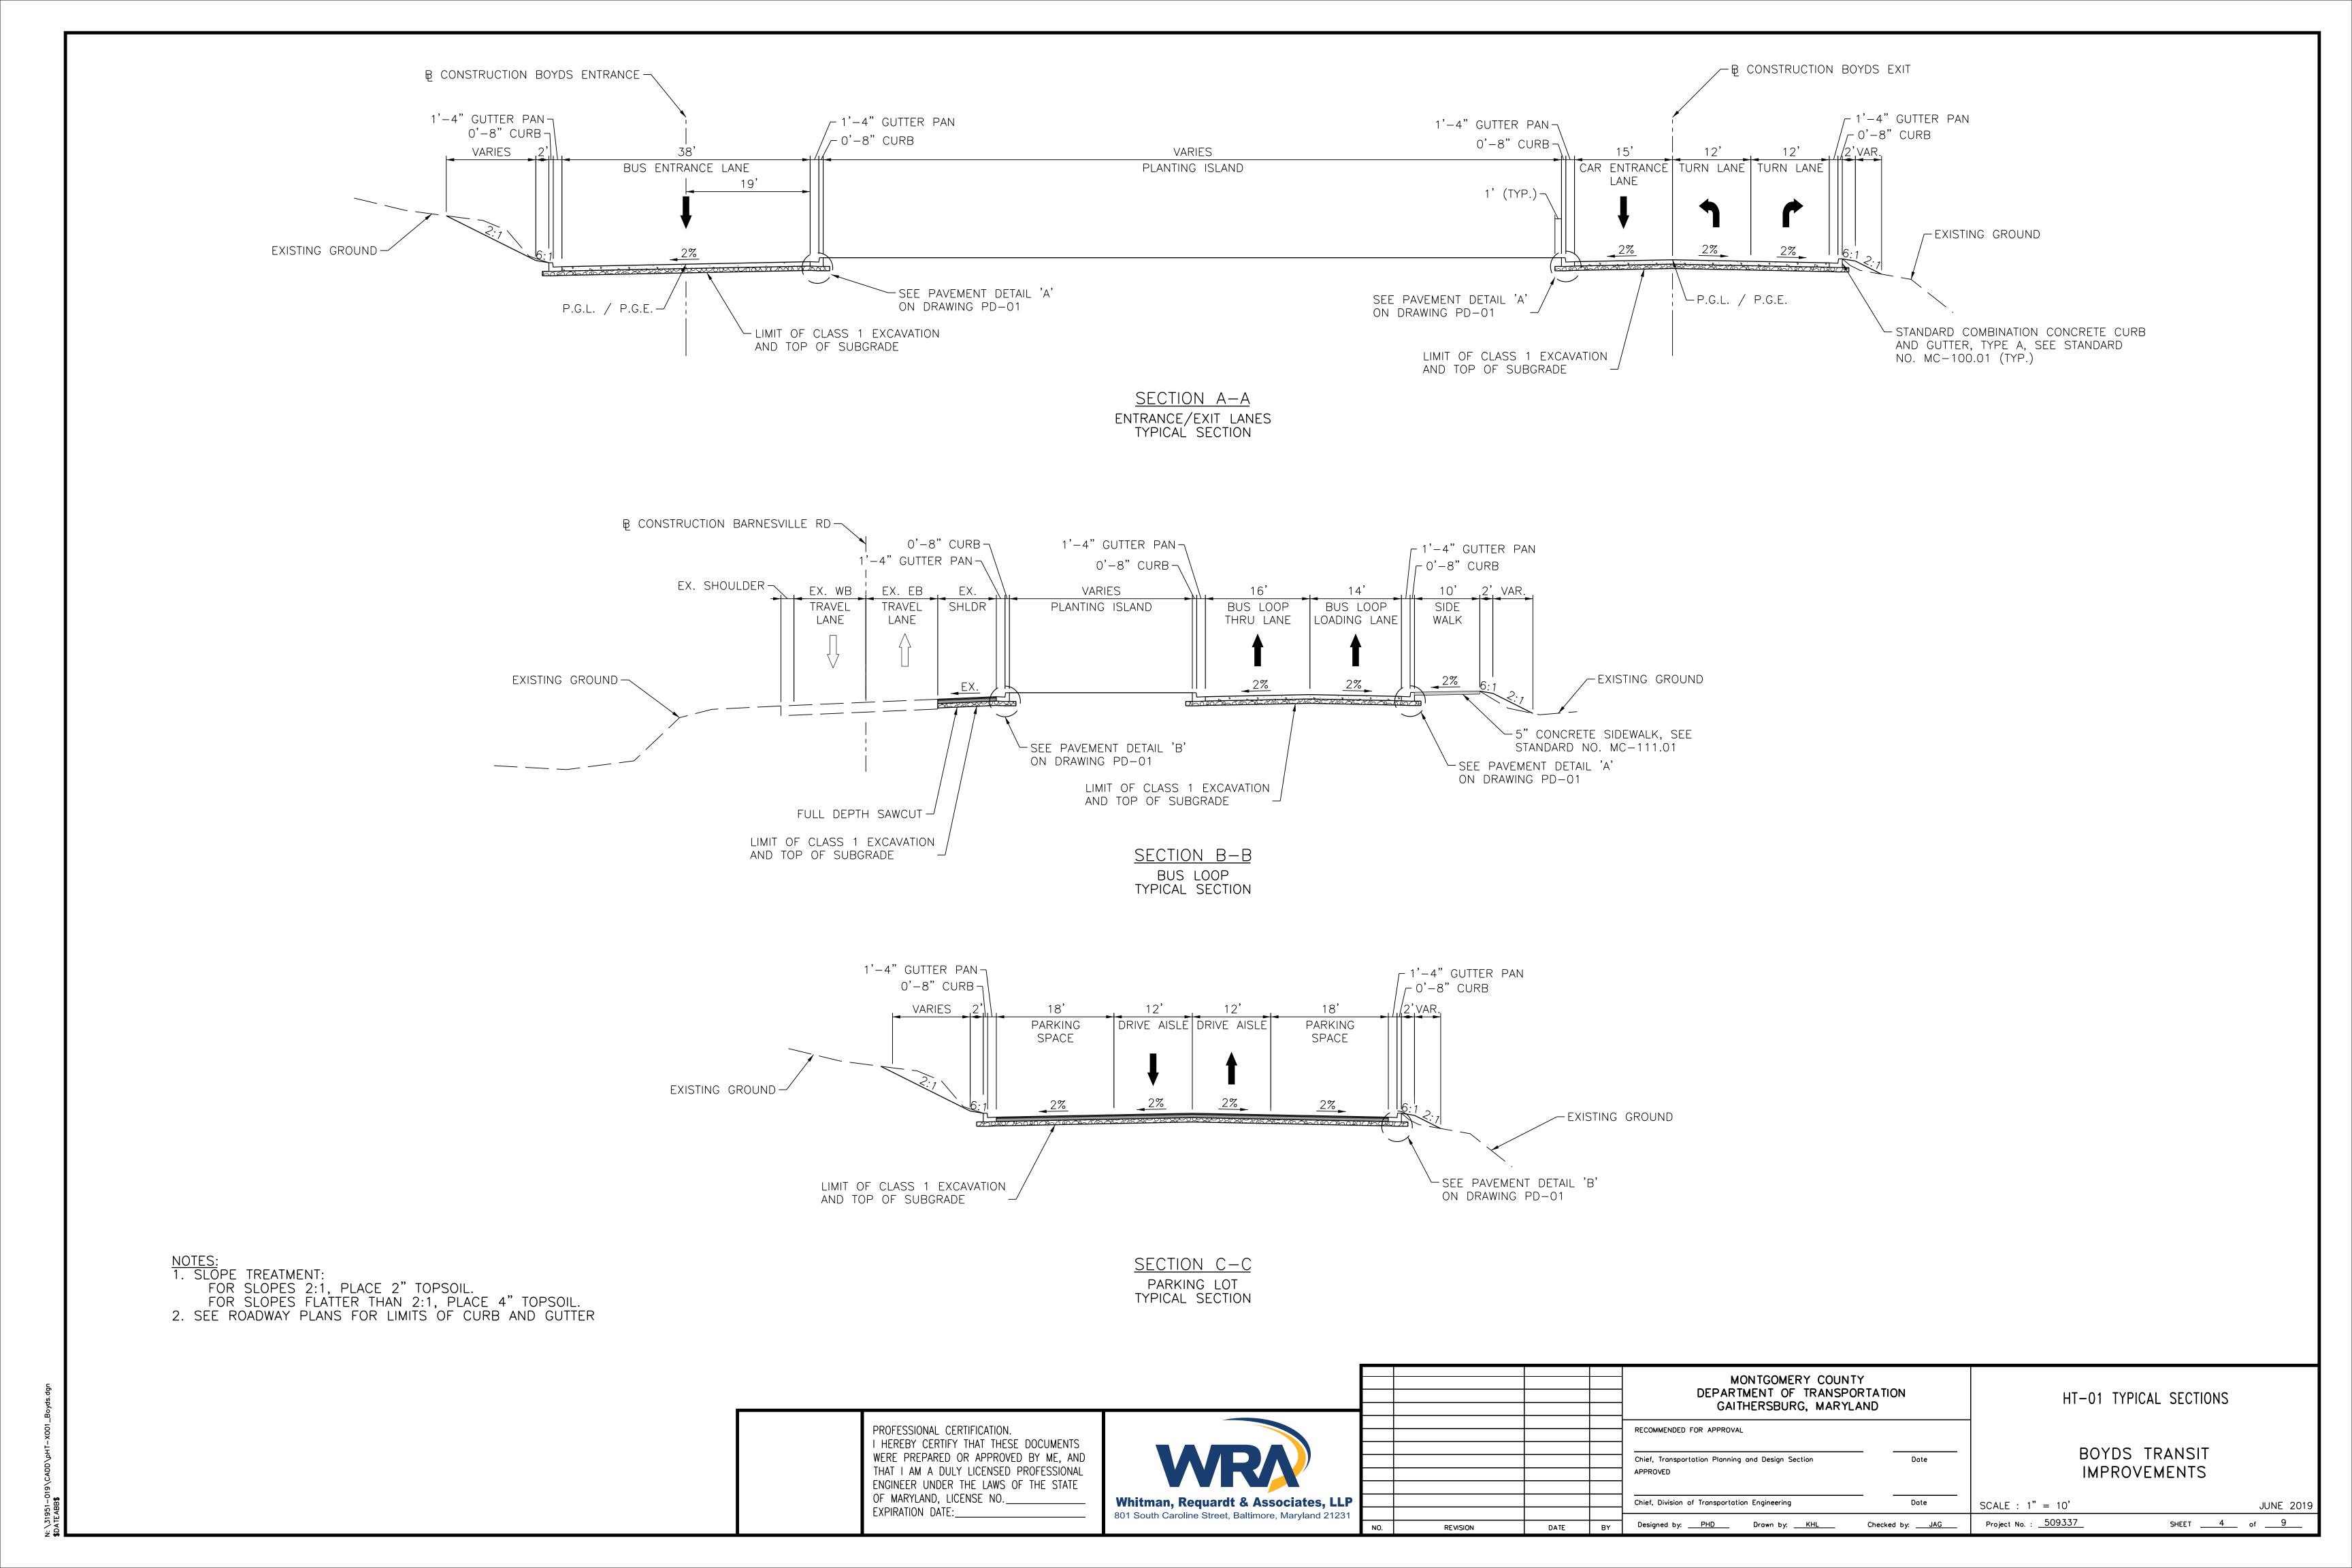

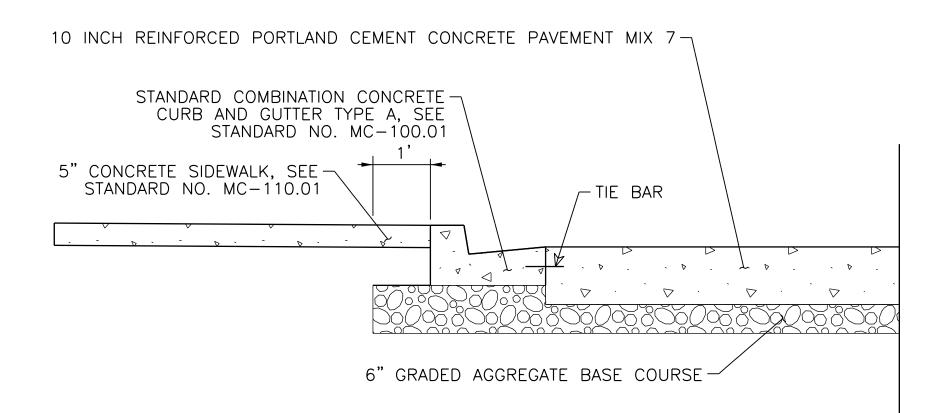

PAVEMENT DETAIL 'A'
NOT TO SCALE

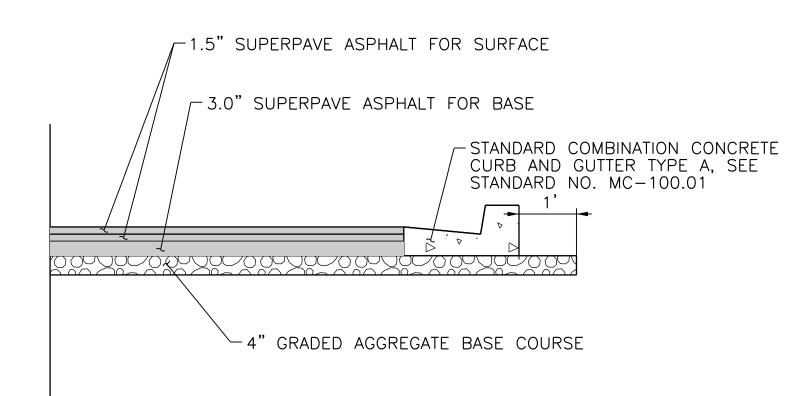

PAVEMENT DETAIL 'B'

PROFESSIONAL CERTIFICATION.

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ENGINEER UNDER THE LAWS OF THE STATE
OF MARYLAND, LICENSE NO.

EXPIRATION DATE:




				MONTGOMERY COUNTY DEPARTMENT OF TRANSPORTATION GAITHERSBURG, MARYLAND		
				RECOMMENDED FOR APPROVAL		_
				Chief, Transportation Planning and Design Section APPROVED	Date	
				Chief, Division of Transportation Engineering	Date	5
NO.	REVISION	DATE	BY	Designed by: <u>PHD</u> Drawn by: <u>KHL</u> Cr	necked by:JAG	


PD-01 PAVEMENT DETAILS


BOYDS TRANSIT IMPROVEMENTS


 SCALE : 1" = 10'
 JUNE 2019

 Project No. : 509337
 SHEET 5 of 9

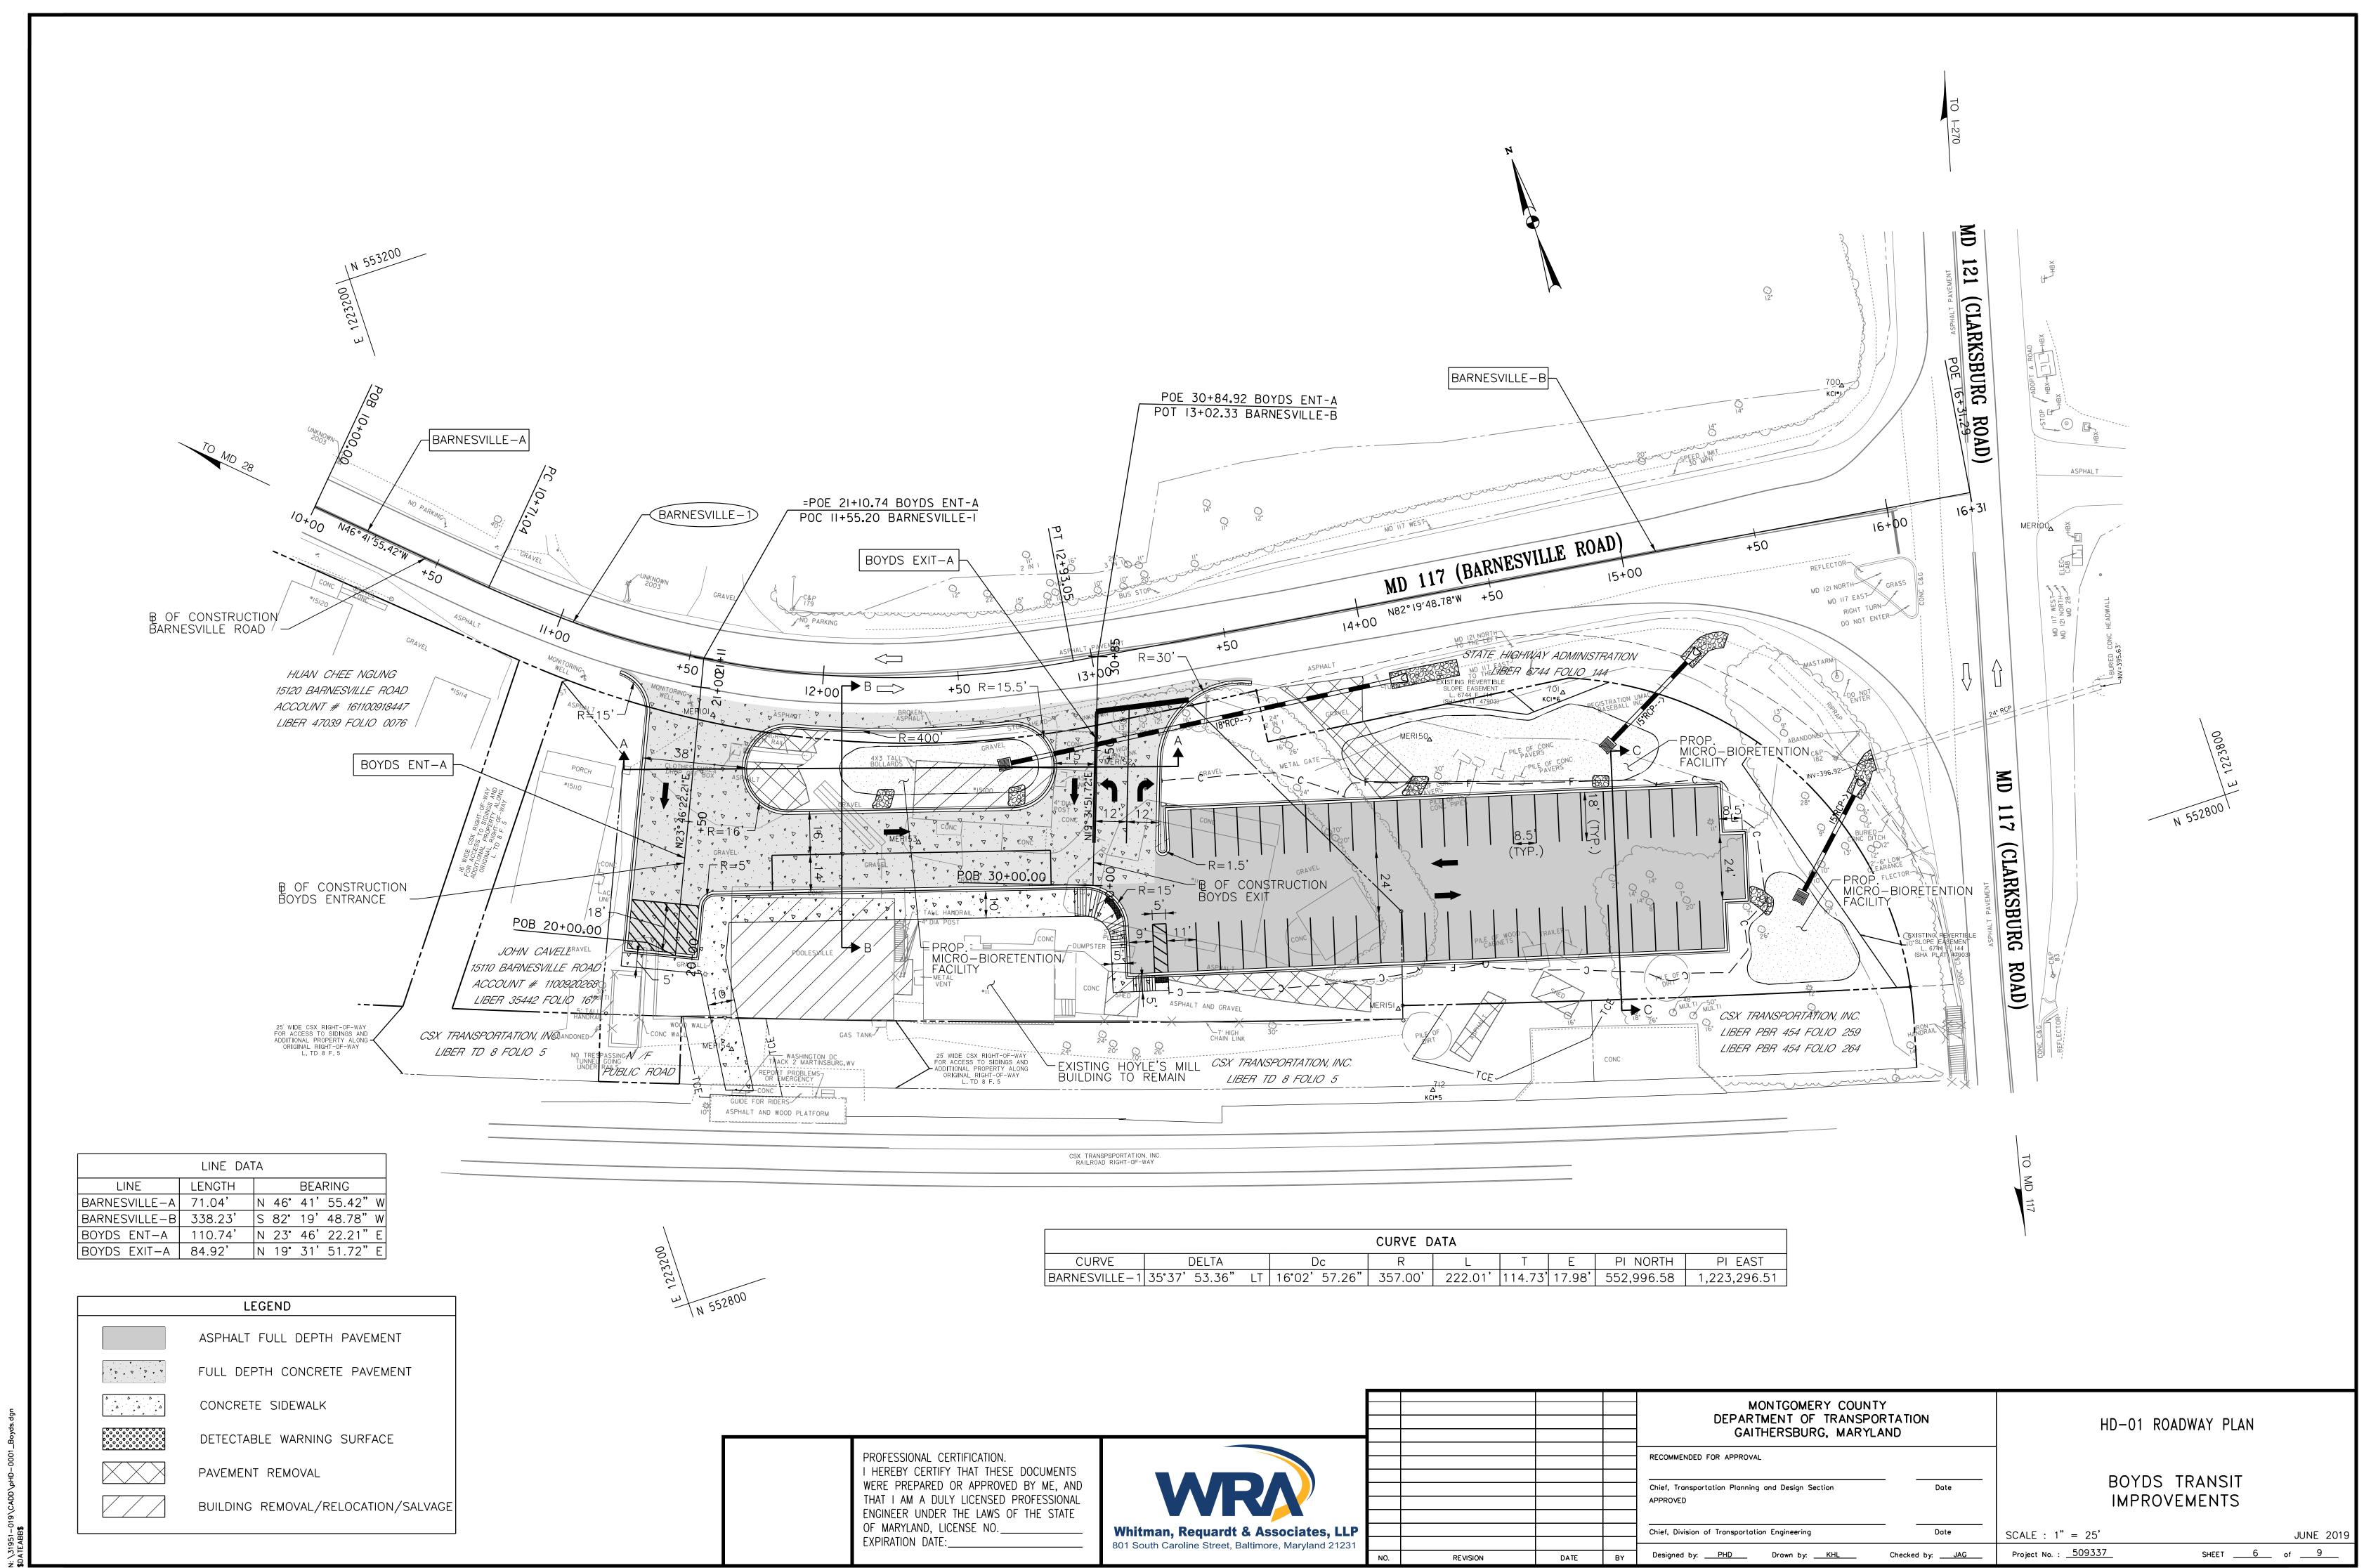

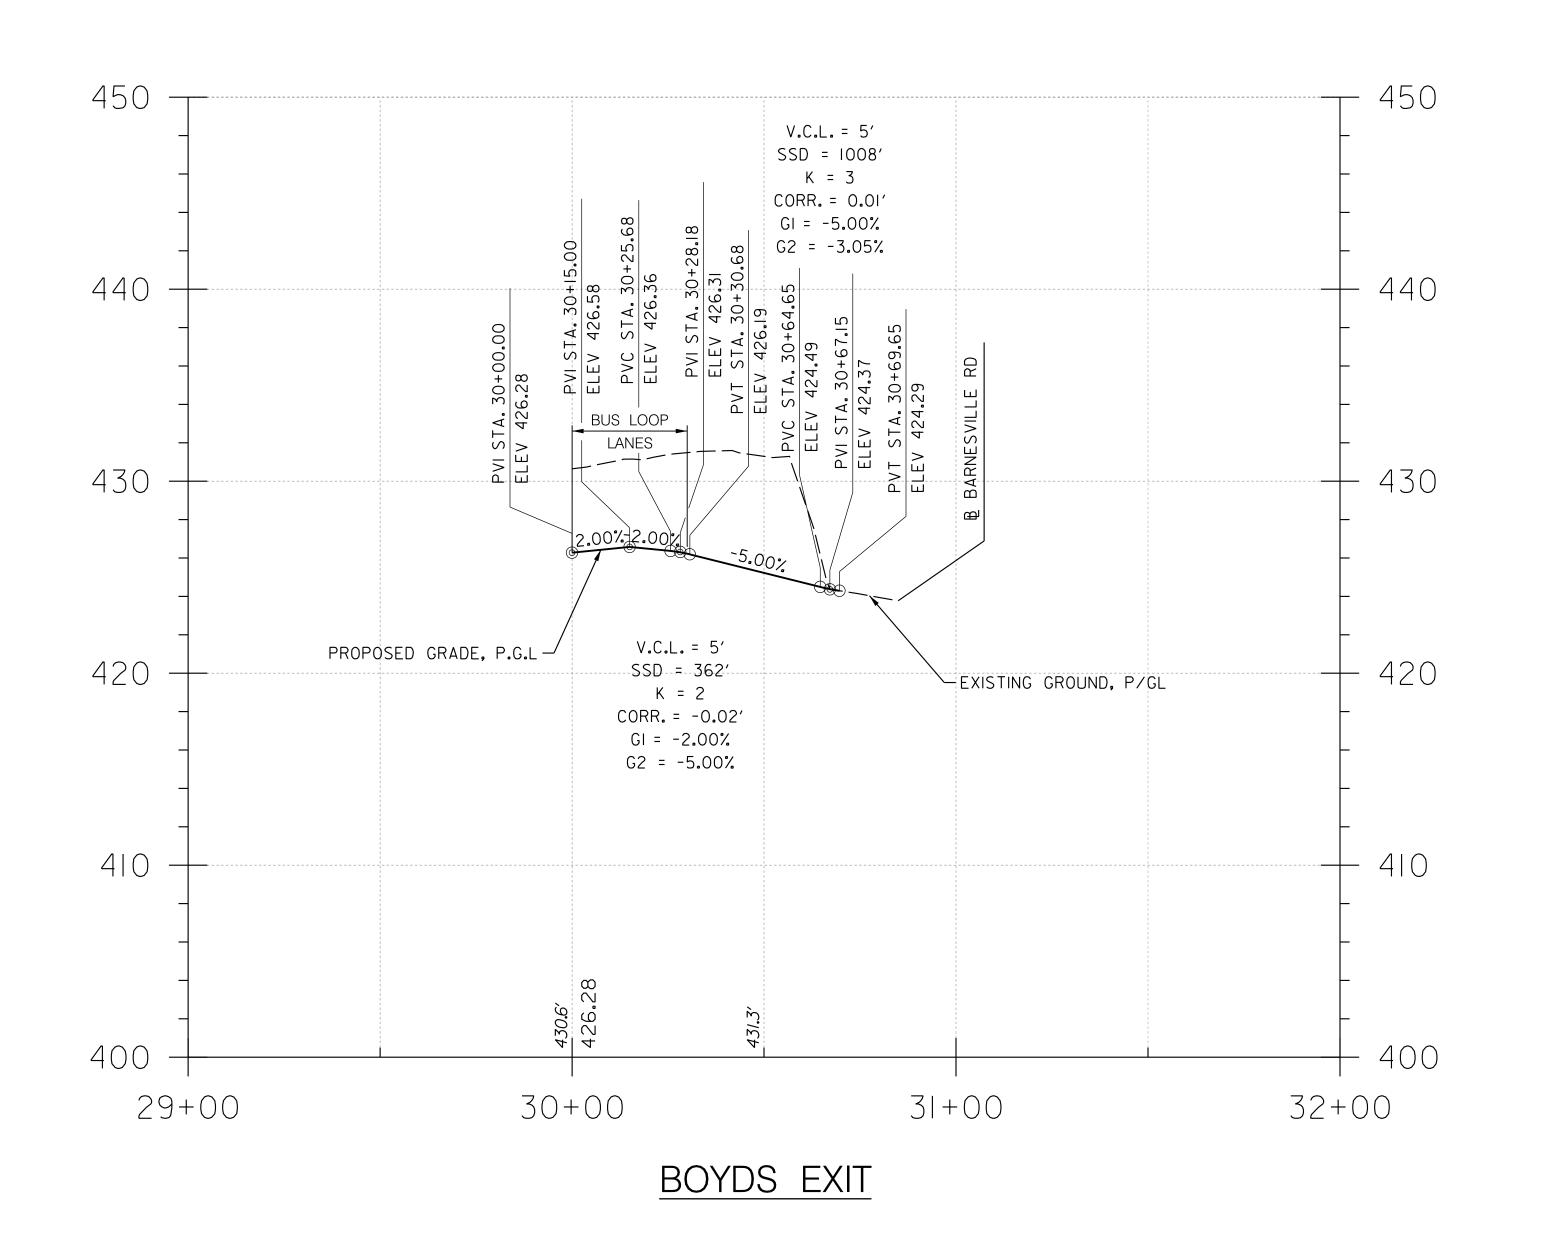

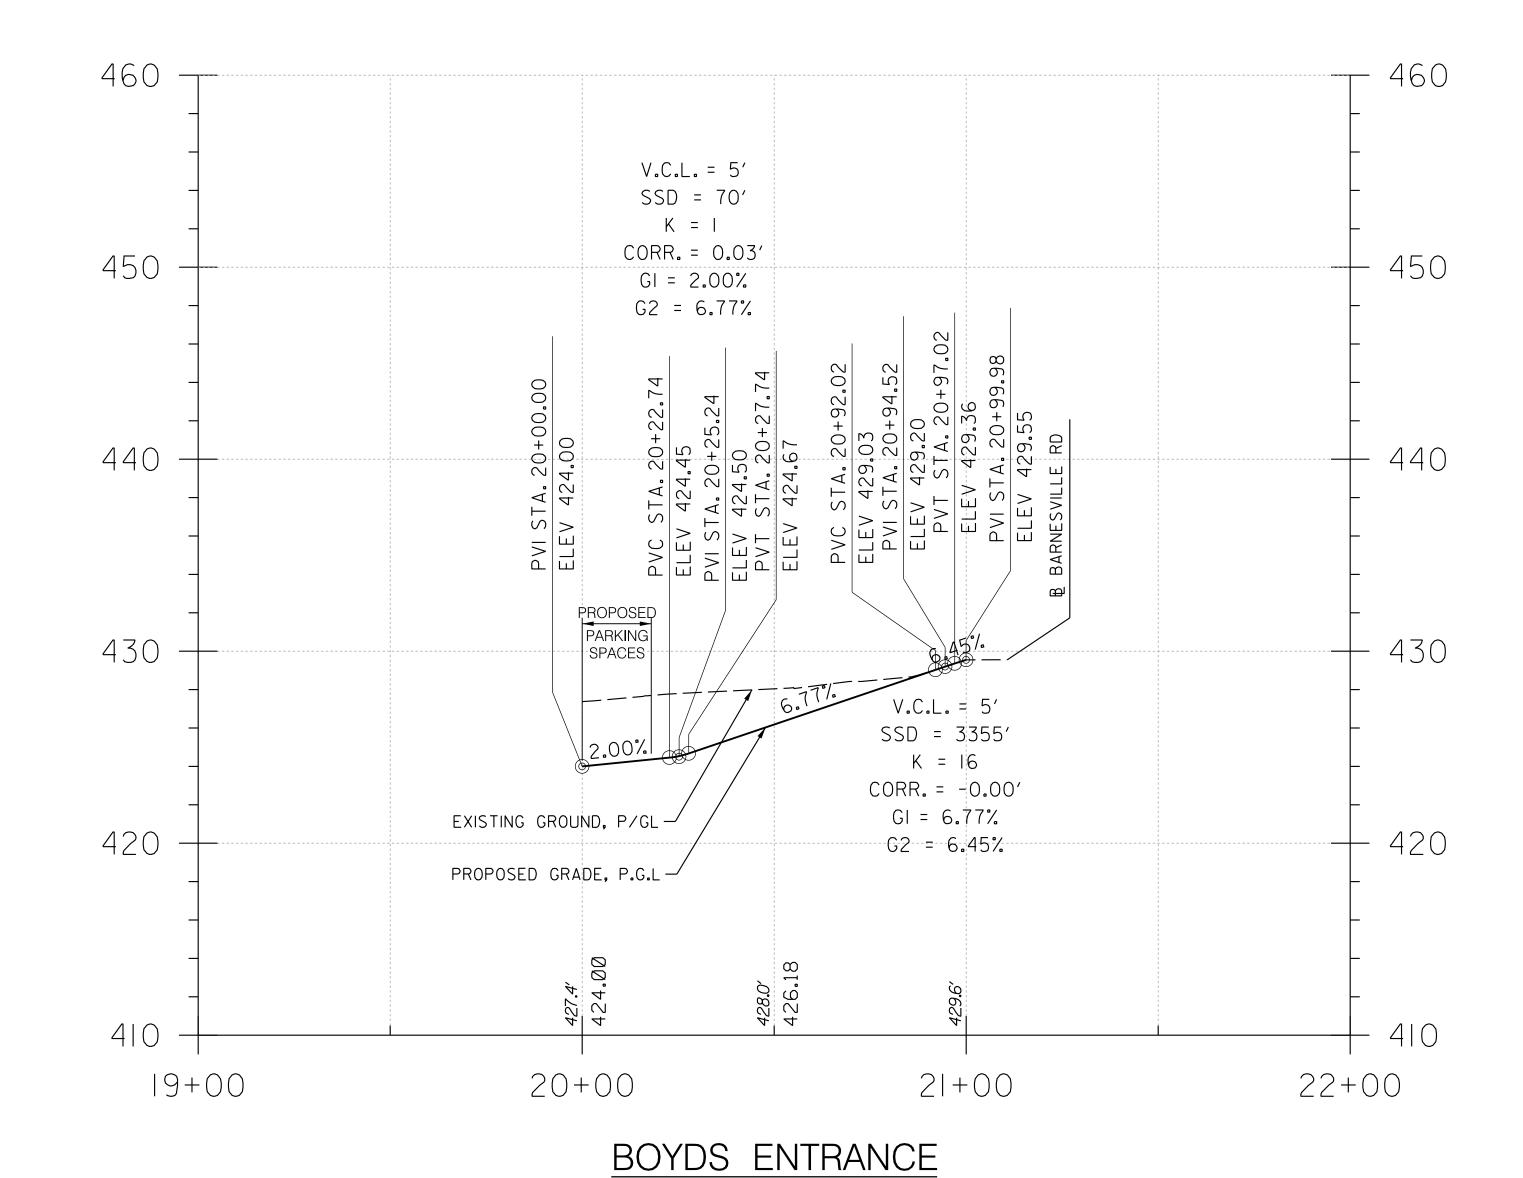

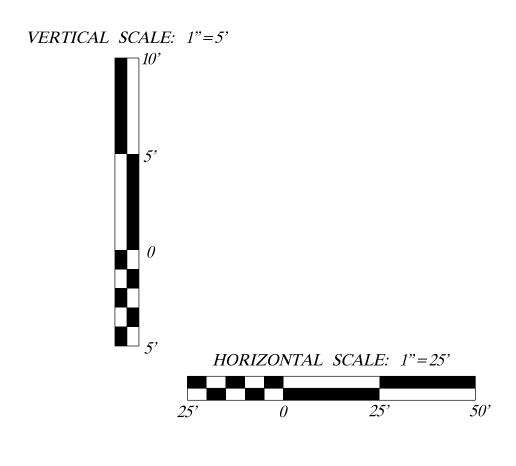

PROFESSIONAL CERTIFICATION.

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OF MARYLAND, LICENSE NO.

EXPIRATION DATE:_




				MONTGOMERY COUNTY DEPARTMENT OF TRANSPORTATION GAITHERSBURG, MARYLAND		
				RECOMMENDED FOR APPROVAL		
				Chief, Transportation Planning and Design Section APPROVED	Date	
				Chief, Division of Transportation Engineering	Date	SCAL
NO.	REVISION	DATE	BY	Designed by: <u>PHD</u> Drown by: <u>KHL</u> Che	cked by: <u>JAG</u>	Projec

HP-01 ROADWAY PROFILE

BOYDS TRANSIT **IMPROVEMENTS**

1"= 25' H ALE : 1"= 10' V JUNE 2019 oject No. : <u>509337</u> SHEET _____7 of ____9

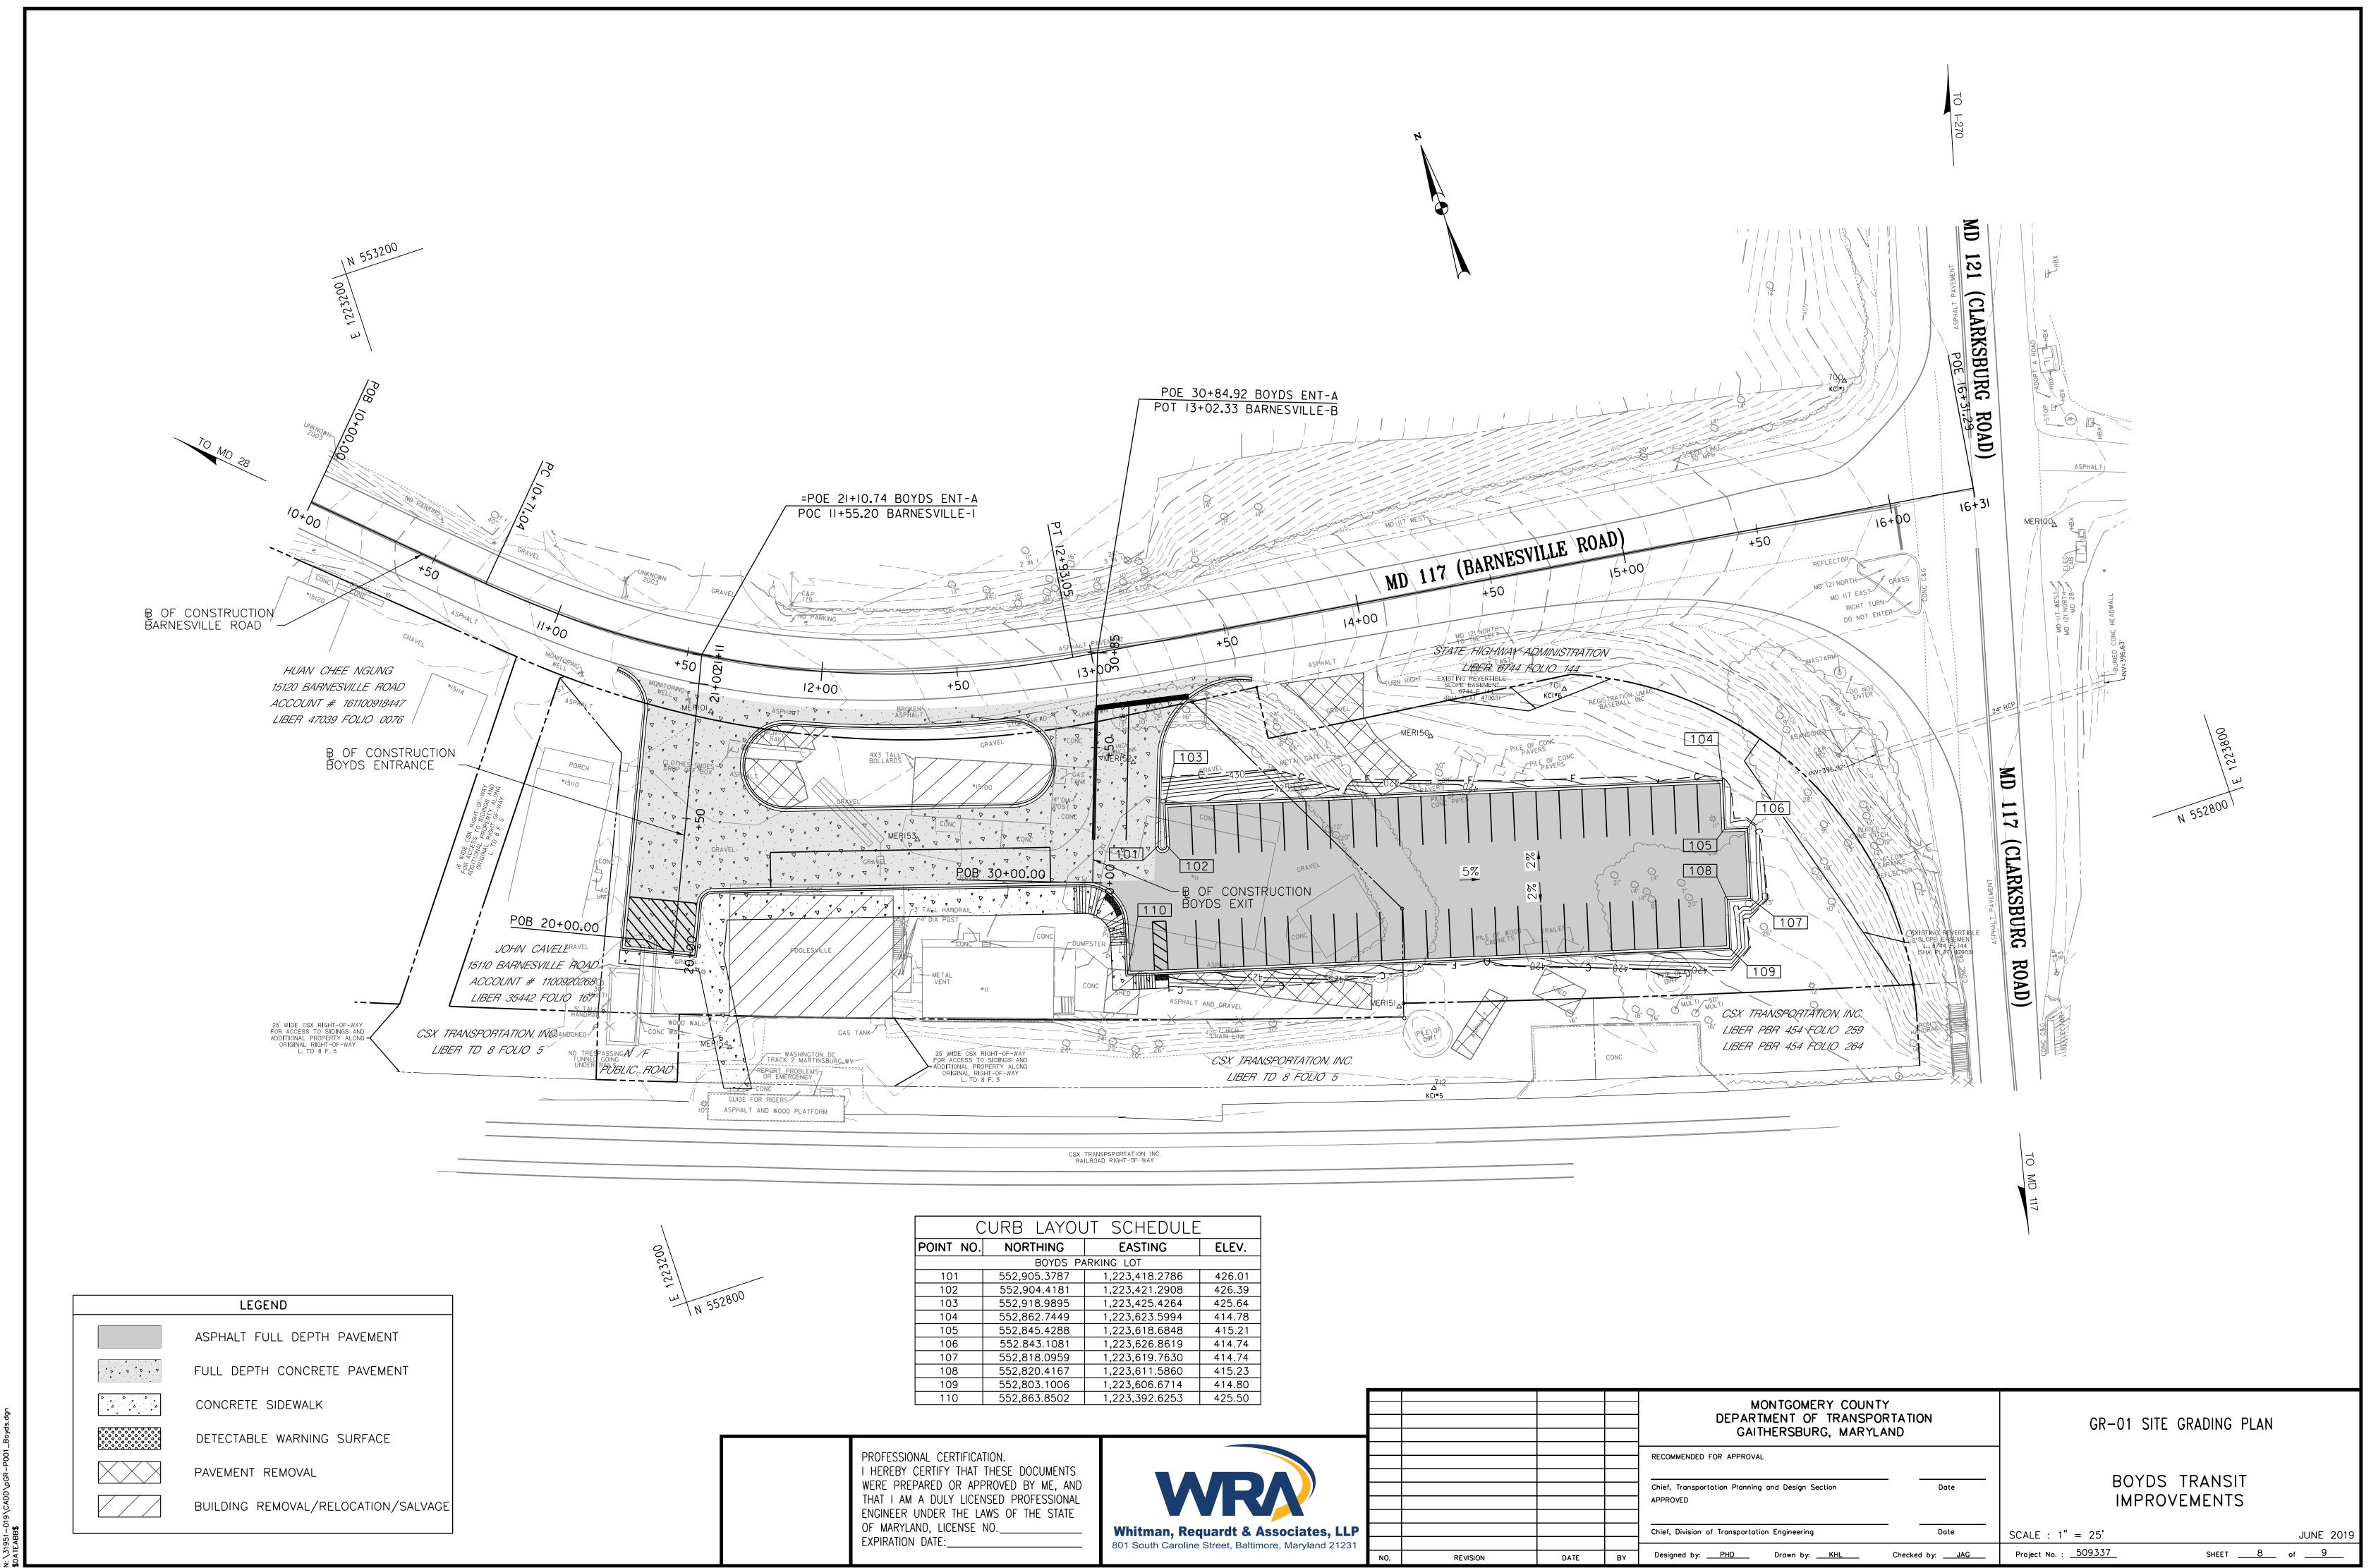

\31951-019\CADD\oGR-P001 Boxds.dor

