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**MONTGOMERY COUNTY
DEPARTMENT OF TRANSPORTATION**

**NORWOOD ROAD
SHARED USE PATH**

C. I. P. PROJECT NO. 502313

RELATED REQUIRED PERMITS					
IT IS THE RESPONSIBILITY OF PERMITTEE/OWNER OF THIS SITE TO OBTAIN ALL REQUIRED PERMITS PRIOR TO ISSUANCE OF THE APPROVED SEDIMENT CONTROL PERMIT					
TYPE OF PERMIT	REQD	NOT REQD	PERMIT #	EXPIRATION DATE	WORK RESTRICTION DATES
MCDPS Floodplain District		X			
WATERWAYS/WETLAND(S):					
a. Corps of Engineers	X				
b. MDE	X				
c. MDE Water Quality Certification		X			
MDE Dam Safety		X			
*DPS Roadside Trees Protection Plan	X		MCDOT BLANKET PERMIT NO. 361405	Approval Date	DATE FILED
N.P.D.E.S. NOTICE OF INTENT		X			
TOW OWNER (Required Post Construction)		X			
OTHERS:					
DPS Erosion and Sediment Control	X				
MNCPPC Permit		X			
* A copy of the Roadside Trees Protection Plan must be delivered to the sediment control inspector at the preconstruction meeting.					
OWNER/PERMIT APPLICANT INFORMATION					
NAME: MONTGOMERY COUNTY DEPARTMENT OF TRANSPORTATION					
ADDRESS: 100 EDISON PARK DRIVE, 4TH FLOOR, GAITHERSBURG, MD 20878					
PHONE NUMBER: (240) 777-7263					
CONTACT PERSON: REBECCA PARK, P.E.					

DRAINAGE STATEMENT


I understand that DPS approval of this sediment control/stormwater management plan is for demonstrated compliance with required environmental runoff treatment standards. This DPS sediment control/stormwater management plan approval does not relieve me of professional responsibility. I have analyzed the proposed design for sediment control permit no. _____ and hereby certify that, based upon my background, training and experience, I have determined that the proposed improvements shown on this plan meet relevant laws and regulations. I further acknowledge that I have analyzed the post development drainage patterns for this project from the standpoint of my responsibilities under current Maryland Law and have determined that if permission is required from adjacent property owners, I have obtained it and have made copies of those permissions available to DPS.

Engineer's Signature _____

Date _____

Printed Name _____

TREE CANOPY REQUIREMENTS TABLE	
To be completed by the consultant and placed on the first sheet of the Sediment Control / Stormwater Management plan set for all projects.	
Exempt: Yes <input type="checkbox"/> No <input checked="" type="checkbox"/> If exempt under Section 55-5 of the Code, please check the applicable exemption category below.	
Total Property Area	Total Disturbed Area
505,778 square feet	39,184 square feet
Shade Trees Required	Shade Trees Proposed to be Planted
15	0
Fee in Lieu (Trees Required - Trees Planted) x \$250	\$ 3,750
Required Number of Shade Trees	
Area (sq. ft.) of the Limits of Disturbance	Number of Shade Trees Required
FROM TO	
1 6,000	3
6,001 8,000	6
8,001 12,000	9
12,001 14,000	12
14,001 40,000	15
If the square footage of the limits of disturbance is more than 40,000, then the number of shade trees required must be calculated using the following formula:	
(Number of Square Feet in Limits of Disturbance ÷ 40,000) × 15	
EXEMPTION CATEGORIES:	
<input type="checkbox"/> 55-5(a) any activity that is subject to Article II of Chapter 22A; <input type="checkbox"/> 55-5(b) any commercial logging or timber harvesting operation with an approved exemption from Article II of Chapter 22A; <input type="checkbox"/> 55-5(f) any activity conducted by the County Parks Department; <input type="checkbox"/> 55-5(g) routine or emergency maintenance of an existing stormwater management facility, including an existing access road, if the person performing the	maintenance has obtained all required permits; <input type="checkbox"/> 55-5(h) any stream restoration project if the person performing the work has obtained all necessary permits; <input type="checkbox"/> 55-5(i) cutting or clearing any tree to comply with applicable provisions of any federal, state, or local law governing safety of dams; <input type="checkbox"/> OTHER: Specify per Section 55-5 of the Code.

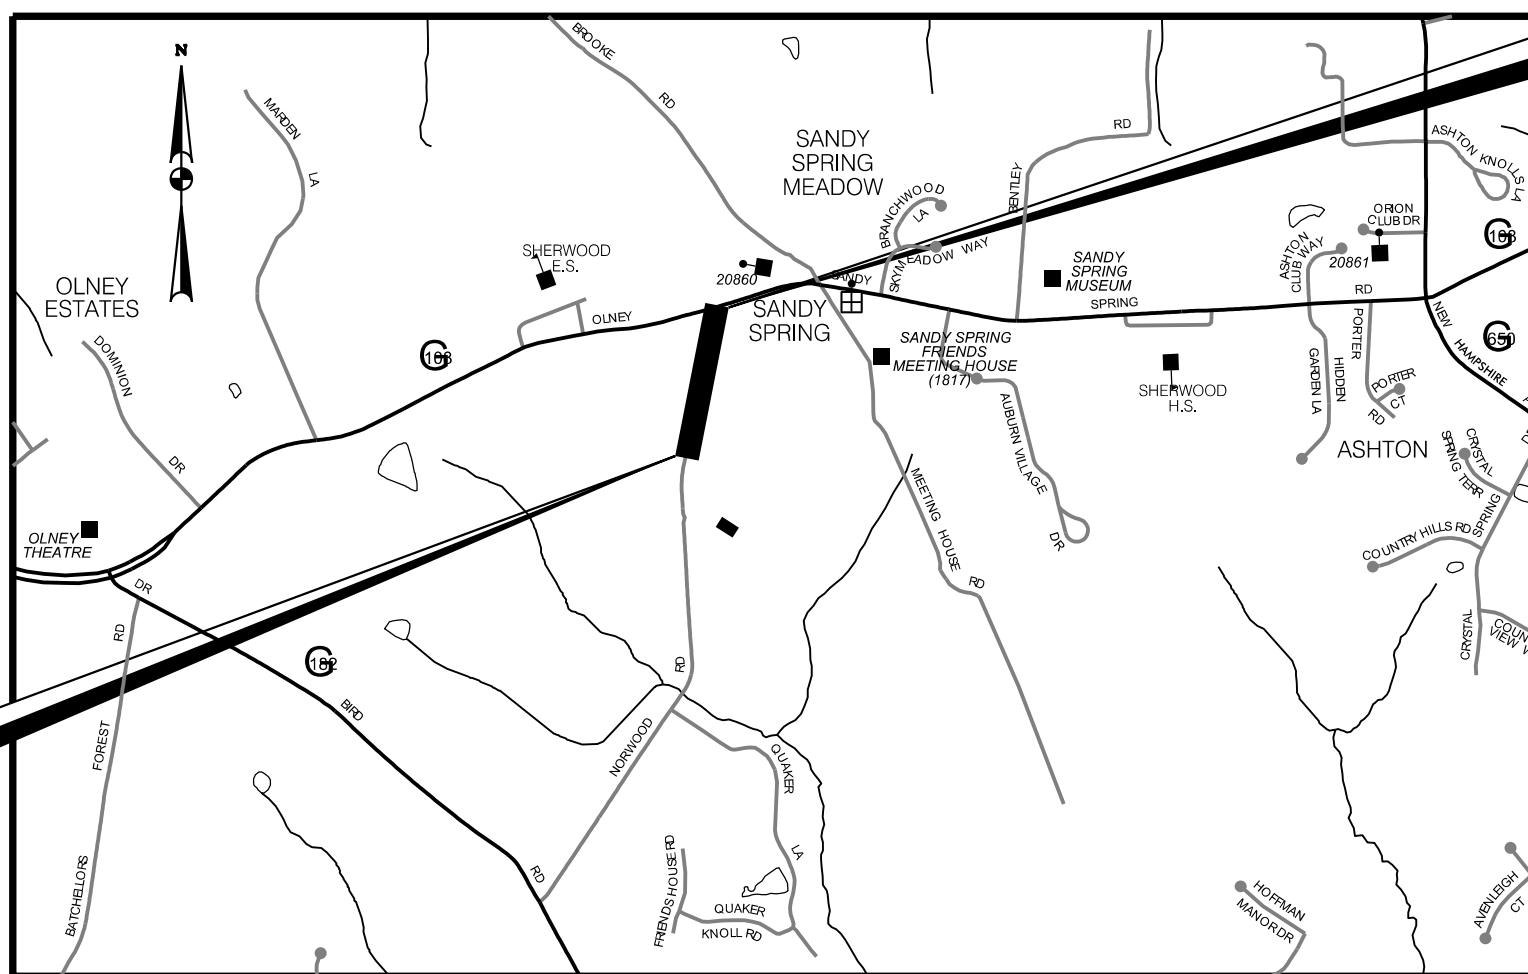

VICINITY MAP
MONTGOMERY COUNTY
LENGTH OF PROJECT:
NORWOOD ROAD = 0.70 MILES
SCALE : 1" = 2000'

**LIMIT OF WORK
CONTR. NO. 502313
SHARED USE PATH**

**LIMIT OF WORK
CONTR. NO. 502313
SHARED USE PATH**

GENERAL NOTES

- ALL CONSTRUCTION SHALL BE DONE IN ACCORDANCE WITH THE LATEST EDITION OF THE STANDARD SPECIFICATIONS OF THE MARYLAND STATE HIGHWAY ADMINISTRATION JULY 2023 AND MONTGOMERY COUNTY DESIGN STANDARDS.
- INFORMATION CONCERNING UNDERGROUND UTILITIES WAS OBTAINED FROM AVAILABLE RECORDS, BUT THE CONTRACTOR MUST DETERMINE THE EXACT LOCATIONS AND ELEVATIONS OF THE LINES BY DIGGING TEST PITS BY HAND AT ALL UTILITY CROSSINGS, WELL IN ADVANCE OF TRENCHING. IF CLEARANCES ARE LESS THAN SHOWN OR SIX (6) INCHES, WHICHEVER IS LESS, CONTACT MONTGOMERY COUNTY DEPARTMENT OF TRANSPORTATION'S PROJECT INSPECTOR AND THE APPROPRIATE UTILITY OWNER BEFORE PROCEEDING WITH CONSTRUCTION.
- REPAIRS TO UTILITIES OR PROPERTY DAMAGE AS A RESULT OF THE CONTRACTOR'S NEGLIGENCE OR METHOD OF OPERATION MUST BE MADE AT THE CONTRACTOR'S EXPENSE BEFORE PROCEEDING WITH CONSTRUCTION.
- CALL "MISS UTILITY" AT 1-800-257-7777 FORTY-EIGHT (48) HOURS PRIOR TO BEGINNING EXCAVATION TO DETERMINE THE EXACT LOCATION OF EXISTING UTILITIES.
- CLEARING IS TO BE LIMITED TO THE "LIMIT OF GRADING" AS SHOWN ON THE PLANS.
- ALL GRADING SHALL BE DONE IN SUCH A MANNER AS TO PROVIDE POSITIVE DRAINAGE.
- ALL DISTURBED AREAS TO BE SEEDED AND MULCHED UNLESS OTHERWISE NOTED.
- THE CONTRACTOR SHALL OBTAIN A ROADSIDE TREE PERMIT FOR ANY MAINTENANCE, TREATMENT, PLANTING, REMOVAL, OR ROOT CUTTING ON TREES WITHIN THE PUBLIC RIGHT OF WAY. PERMIT REQUIREMENTS MAY BE OBTAINED FROM THE DEPARTMENT OF NATURAL RESOURCES, MARYLAND FOREST, PARK AND WILDLIFE SERVICE, TELEPHONE 301-854-6060.
- THE PERMITTEE SHALL REFER TO THE ATTACHED TEMPORARY TRAFFIC CONTROL PLAN (TTCP) DRAWINGS TO SELECT THE APPROPRIATE WORK ZONE TEMPORARY TRAFFIC CONTROLS FOR EACH PHASE OF CONSTRUCTION. WORK ZONE SITUATIONS WHICH ARE NOT ADDRESSED IN THE ATTACHED TTCP SHALL CONFORM TO THE GUIDELINES SET FORTH IN SECTION 6 OF THE MANUAL ON UNIFORM TRAFFIC CONTROL DEVICES FOR STREETS AND HIGHWAYS (MUTCD), MOST RECENT EDITION.
- FOR CONSTRUCTION, ALL HORIZONTAL AND VERTICAL CONTROLS SHALL BE NAD 83 (2007) AND NAVD 88 DATUM.

OWNER'S/DEVELOPER'S CERTIFICATION

I/We hereby certify that all clearing, grading, construction, and or development will be done pursuant to this plan and that any responsible personnel involved in the construction project will have a Certificate of Attendance at a Department of Natural Resources approved training program for the control of sediment and erosion before beginning the project.

DATE _____

JOSE THOMMANA
CHIEF, DIVISION OF TRANSPORTATION ENGINEERING

DESIGN CERTIFICATION

I hereby certify that this plan has been prepared in accordance with the "2011 Maryland Standards and Specification for Soil Erosion and Sediment Control," Montgomery County Department of Permitting Services Executive Regulations 5-90, 7-02AM and 36-90, and Montgomery County Department of Public Works and Transportation "Storm Drain Design Criteria" dated August 1988.

DATE _____

MICHAEL MERCADO, P.E.
MERCADO CONSULTANTS, INC.

CERTIFICATION OF THE QUANTITIES

I hereby certify that the estimated total yards of excavation and fill as shown on this plan has been computed to 250 cubic yards of excavation, 70 cubic yards of fill and the total area to be disturbed as shown on these plans has been determined to be 39,184 square feet.

SIGNATURE _____

DATE _____

MICHAEL MERCADO, P.E.
PRINTED NAME AND TITLE

38931
REGISTRATION NUMBER

NO.	REVISION	DATE	BY



PROFESSIONAL CERTIFICATION:
I HEREBY CERTIFY THAT THESE DOCUMENTS WERE PREPARED OR APPROVED BY ME, AND THAT I AM A DULY LICENSED PROFESSIONAL ENGINEER UNDER THE LAWS OF THE STATE OF MARYLAND.
LICENSE NO: 38931 EXPIRATION DATE: 12-22-2023

65% DESIGN SUBMISSION 11-20-2023

TECHNICAL REVIEW OF SEDIMENT CONTROL	ADMINISTRATIVE REVIEW
REVIEWED DATE	REVIEWED DATE
TECHNICAL REVIEW OF STORMWATER MANAGEMENT	SMALL LOT DRAINAGE APPROVAL
	N/A: <input checked="" type="checkbox"/> OR
REVIEWED DATE	REVIEWED DATE
MCDPS APPROVAL OF THIS PLAN WILL EXPIRE TWO YEARS FROM THE DATE OF APPROVAL IF THE PROJECT HAS NOT STARTED.	NOTE: MCDPS APPROVAL DOES NOT NEGATE THE NEED FOR A MCDPS ACCESS PERMIT.

MONTGOMERY COUNTY DEPARTMENT OF TRANSPORTATION
DIVISION OF TRANSPORTATION ENGINEERING
GAITHERSBURG, MARYLAND

RECOMMENDED FOR APPROVAL

Chief, Design Section _____ Date _____
APPROVED

Chief, Division of Transportation Engineering _____ Date _____

Designed by : MWM Drawn by : NL Checked by : MWM

**NORWOOD ROAD
SHARED USE PATH**

TITLE SHEET

SCALE : AS SHOWN DATE : NOVEMBER, 2023

Project No. : 502313 SHEET 1 of 20

ABBREVIATIONS

AASHTO..... American Association of State Highway Transportation Officials	HP..... High Point	R.Q.D..... Rock Quality Designation
ADT..... Average Daily Traffic	IN..... Inch	R.M..... Rootmat
AHD..... Ahead	INV..... Invert	S..... South
APPROX..... Approximate	J.B..... Junction Box	SAN..... Sanitary Sewer
□ or B/L..... Baseline	K..... K Inlet	SB or S/B..... Southbound
BK..... Back / Book	L..... Length	S.D..... Storm Drain
BIT..... Bituminous	LF..... Linear Feet	S.D.D..... Surface Drain Ditch
B.C..... Bituminous Concrete	LL..... Liquid Limit	S/E..... Super Elevation
B.M..... Bench Mark	LOD..... Limit of Disturbance	SF..... Silt Fence
BOT..... Bottom	LP..... Low Point	SF..... Square Feet
C.C..... Center of Curve	L.P..... Light Pole	SHT..... Sheet
CAP..... Corrugated Aluminum Pipe	LT..... Left	SPP..... Structural Steel Plate Pipe
CAPA..... Corrugated Aluminum Pipe Arch	MAC..... Macadam	SPPA..... Structural Steel Plate Pipe Arch
CATV..... Cable Television	M.C..... Moisture Content	S.P.T..... Standard Penetration Testing
C.B.R..... California Bearing Ratio	MAX..... Maximum	SRP..... Steel Spiral Rib Pipe -
□ or C/L..... Centerline	M.D.D..... Maximum Dry Content	Aluminized Type 2
CL..... Class	MOD..... Modified	SRPA..... Steel Spiral Rib Pipe Arch -
CLF..... Chainlink Fence	MIN..... Minimum	Aluminized Type 2
CMP..... Corrugated Metal Pipe	N..... North	SSD..... Stopping Sight Distance
C.O..... Cleanout	NB..... Northbound	SSF..... Super Silt Fence
COMB..... Combination	NE..... Northeast	STD..... Standard
CONC..... Concrete	N.P..... Non-Plastic	STA..... Station
CONSTR..... Construction	O.C..... On Center	SO..... Single Opening
COR..... Corner	OHE..... Overhead Electric	SY..... Square Yards
CORR..... Correction	O.M..... Optimum Moisture	SWM..... Stormwater Management
CPP-S..... Corrugated Polyethylene Pipe - Type 'S'	PAV'T..... Pavement	T..... Tangent
CSP..... Corrugated Steel Pipe - Aluminized Type 2	PC..... Point of Curvature	T..... Telephone
CSPA..... Corrugated Steel Pipe Arch -	PCC..... Point of Compound Curvature	T.C..... Top of Cover
Aluminized Type 2	P/C..... Point of Crown	T.G..... Top of Grate
DC..... Degree of Curve	P/GE..... Profile Grade Elevation	T or TL..... Traverse Line
D.H.V..... Design Hourly Volume	P.G.E..... Profile Ground Elevation	T.M..... Top of Manhole
D.I..... Drop Inlet	P.G.L..... Profile Grade Line	TRAV..... Traverse
DIA..... Diameter	P/GL..... Profile Ground Line	TS..... Temporary Swale
D.O..... Double Opening	P/R..... Point of Rotation	T.S..... Top of Slab
E..... East	P.I..... Plasticity Index	T.S..... Topsoil
E..... Electric	PI..... Point of Intersection	TYP..... Typical
E..... External Distance	POC..... Point On Curve	U.D..... Under Drain
EA..... Each	POT..... Point On Tangent	U.G..... Underground
EB..... Eastbound	PPWP..... Polyvinyl Chloride Profile Wall Pipe	U.P..... Utility Pole
ELEV..... Elevation	PROP..... Proposed	US EPA..... United States Environmental
ES..... End Section	PRC..... Point of Reverse Curve	Protection Agency
ESC..... Erosion and Sediment Control	PT..... Point	USDA..... United States Department
EX or EXIST..... Existing	PT..... Point of Tangency	of Agriculture
FT..... Feet	PVC..... Point of Vertical Curve	VCL..... Vertical Clearance
F or FL..... Flowline	PVC..... Polyvinyl Chloride	V.C.L..... Vertical Curve Length
F.B.D..... Flat Bottom Ditch	PVI..... Point of Vertical Intersection	W..... Water
F.H..... Fire Hydrant	PVRC..... Point of Vertical Reverse Curve	W..... West
FWD..... Forward	PVT..... Point of Vertical Tangency	WB..... Westbound
G..... Gas	R..... Radius	WB..... Wetland Buffer
G.V..... Gas Valve	R.F..... Rock Fragments	W.M..... Water Meter
H.B..... Handbox	RT..... Right	W.S..... Wrapped Steel
HDWL..... Headwall	RW or R/W..... Right of Way	WUS..... Waters of the United States
HERCP..... Horizontal Elliptical Reinforced	RCP..... Reinforced Concrete Pipe	W.V..... Water Valve
Concrete Pipe	RCP..... Reinforced Concrete Pressure Pipe	

SOILS LEGEND

A-3 SAND	A-2-7 CLAYEY SAND	A-7-4 SILTY CLAY
A-2 SAND & FINES	A-7-2 SANDY CLAY	A-7 CLAY
A-2-4 SILTY SAND	A-4 SILT	A-6 COLLOIDAL CLAY
A-4-2 SANDY SILT	A-4-7 CLAYEY SILT	A-5 MICA, DIATOMS

PLAN LOCATION OF SOIL BORINGS BORING TARGETS AND PROFILES SCALE:
HORIZONTAL - NONE
VERTICAL - SEE PROFILE SHEETS

A0-ABOVE OPTIMUM
SAT-SATURATED
LIQ-LIQUEFIED

LL-LIQUID LIMIT (%)
PI-PLASTICITY INDEX (%)
NP-NON-PLASTIC
OMC-OPTIMUM MOISTURE CONTENT (%)
USC-UNIFIED SOIL CLASSIFICATION
USDA-UNITED STATES DEPARTMENT OF AGRICULTURE CLASSIFICATION


TS-TOPSOIL
RM-ROOT MAT
BC-BITUMINOUS CONCRETE
SB-STONE BASE
PCC-PORTLAND CEMENT CONCRETE

W/GR-WITH GRAVEL
W/R-F-WITH ROCK FRAGMENTS

NOTES: SOIL SYMBOLS DENOTE MSMT CLASSIFICATIONS
ALL DIMENSIONS, DEPTHS AND ELEVATIONS ARE NOTED IN FEET
AN ASTERISK AT THE TOP DEPTH OF STRATA INDICATES THAT STRATA WAS VISUALLY CLASSIFIED BY DRILLER
MDD & OMC PER A.A.S.H.T.O. DESIGNATION T-180
N PER A.A.S.H.T.O. DESIGNATION T-206

UNLESS OTHERWISE NOTED ON PLANS, ALL SOIL SURVEY BORINGS FOR ROADWAY CONSTRUCTION WERE LEFT OPEN FOR 24 HOURS WITH NO EXCESS MOISTURE OR FREE WATER ENCOUNTERED DURING TIME OF SOIL SURVEY (09/2000 TO 06/2002)

SOIL BORING PROFILE EXAMPLE

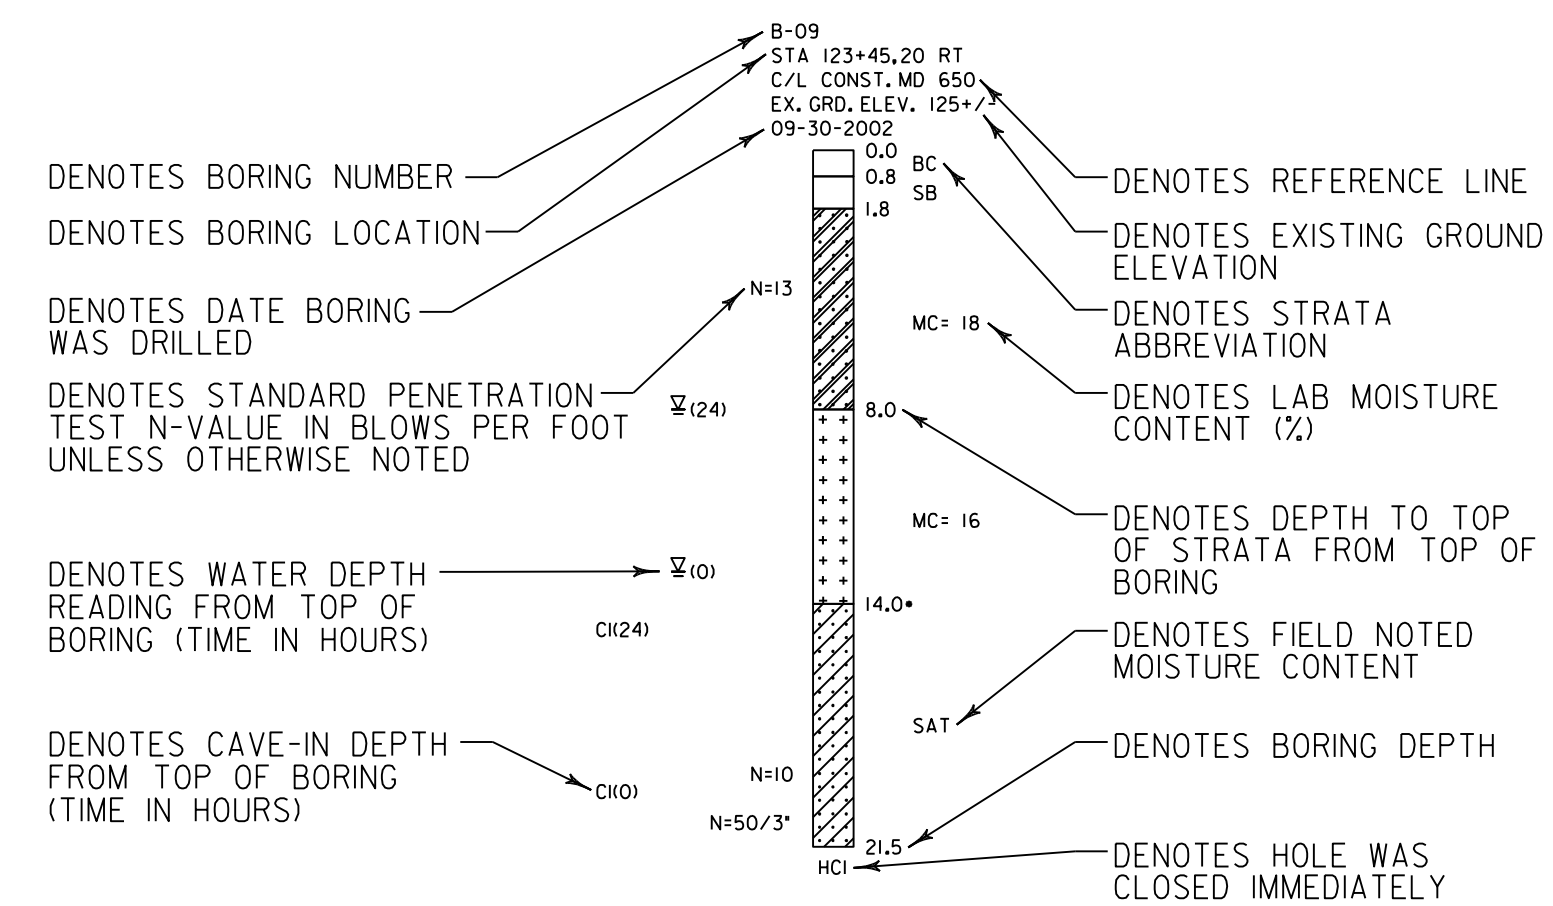












SOILS TEST DATA								
BORING NUMBER	SAMPLE DEPTH	LL	PI	USDA	USC	MDD	OMC	REMARKS
B-09	1.8 - 8.0	18	NP	Sandy Loam	-	-	-	with Gravel
B-09	8.0 - 14.0	41	22	Silty Clay Loam	CL	121	12	-

CONVENTIONAL SIGNS


PROPOSED MEDIAN BARRIER		EXISTING 100 YEAR FLOODPLAIN BOUNDARY	
ELECTRICAL HAND BOX - SIGNALS		PROPOSED 100 YEAR FLOODPLAIN BOUNDARY	
FLOW LINE		WETLAND BOUNDARY	
STATE, COUNTY OR CITY LINES		PROPOSED PIPE / CULVERT	
PROPOSED TRAFFIC BARRIER W-BEAM		EXISTING PIPE / CULVERT	
EXISTING TRAFFIC BARRIER W-BEAM		EXISTING DROP INLET	
PROPOSED FENCE LINE		UTILITY POLE	
EXISTING FENCE LINE		EXISTING WATER	
PROPOSED CURB AND GUTTER		EXISTING SANITARY SEWER	
R/W LINE		EXISTING ELECTRIC	
TEMPORARY CONSTRUCTION EASEMENT		EXISTING OVERHEAD ELECTRIC	
EXISTING ROADWAY		EXISTING FIBER OPTIC	
BASE LINE OR SURVEY LINE		EXISTING TELEPHONE	
FIRE HYDRANT		WETLAND	
HISTORIC BOUNDARY		WETLAND BUFFER	
PARK BOUNDARY		WATERS OF THE U.S.	
WATER LINE		HEDGE / TREE LINE	
OVERHEAD ELECTRIC		BUSH / TREE	
TRAFFIC BARRIER		CONIFEROUS TREE	
		GROUND ELEVATION	
		GRADE ELEVATION	
		PIPE TO BE REMOVED	
		PIPE TO BE ABANDONED	
		DIRECTION OF TRAFFIC FLOW	

				MONTGOMERY COUNTY DEPARTMENT OF TRANSPORTATION ROCKVILLE, MARYLAND		MONTGOMERY COUNTY DEPARTMENT OF TRANSPORTATION DIVISION OF TRANSPORTATION ENGINEERING	
				RECOMMENDED FOR APPROVAL		NORWOOD ROAD SHARED USE PATH	
				Chief, Transportation Planning and Design Section _____ Date _____		NOTES AND ABBREVIATIONS	
				APPROVED		SCALE NONE DATE NOVEMBER, 2023	
				Chief, Division of Transportation Engineering _____ Date _____			
NO.	REVISION	DATE	BY	DESIGNED BY RA	DRAWN BY NM	CHECKED BY MWM	SHEET NO. 2 OF 20



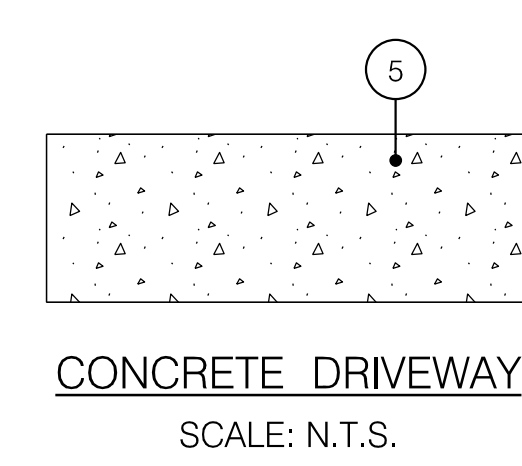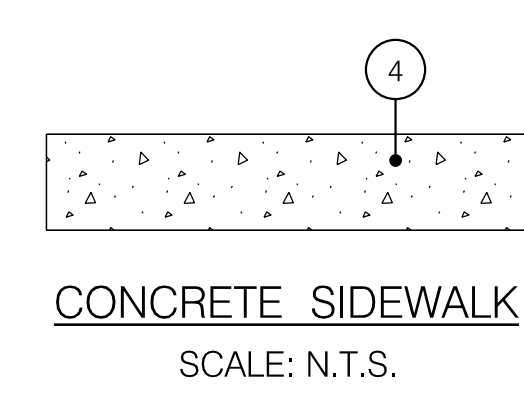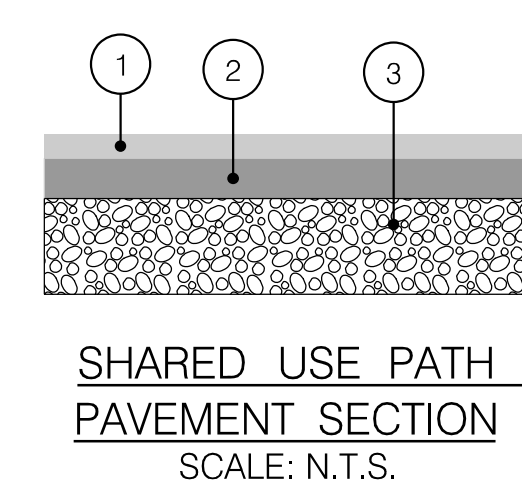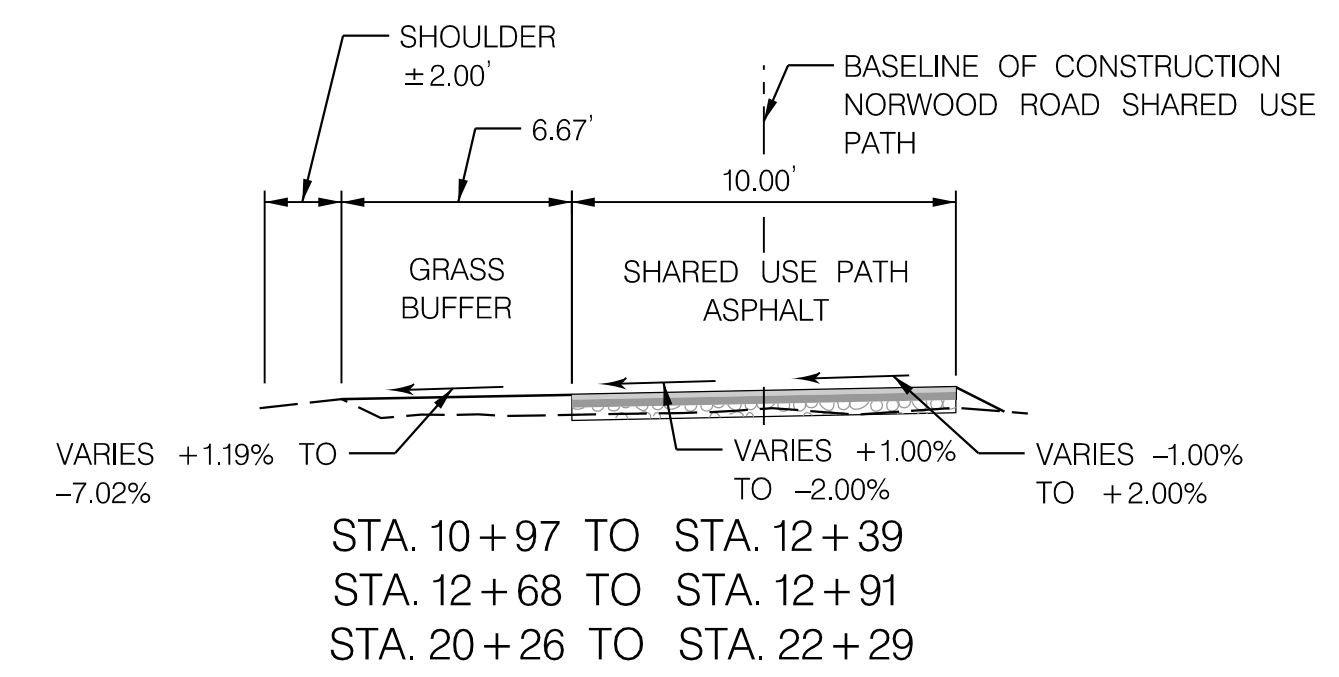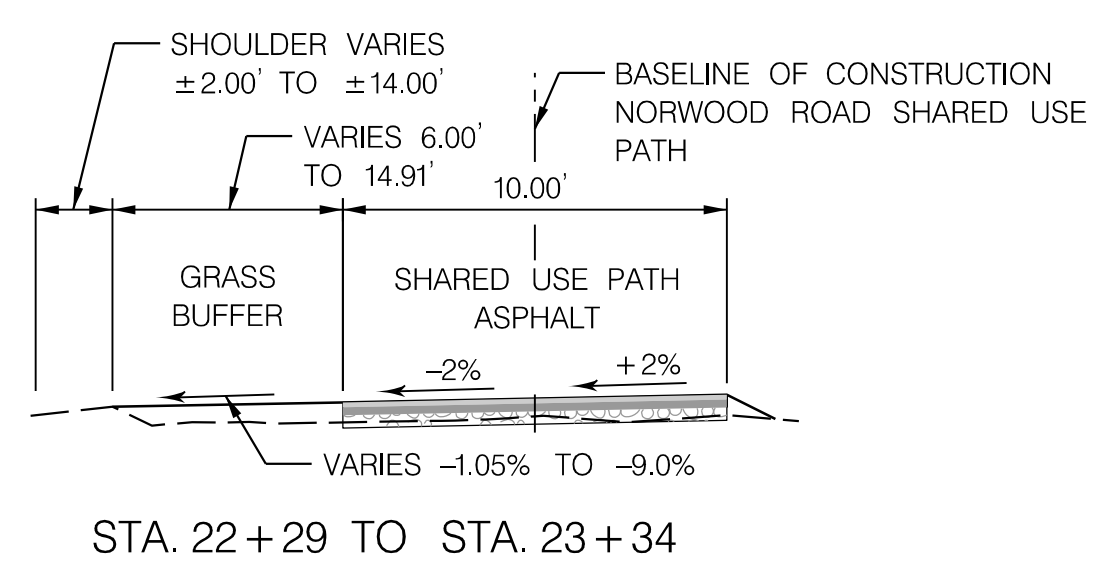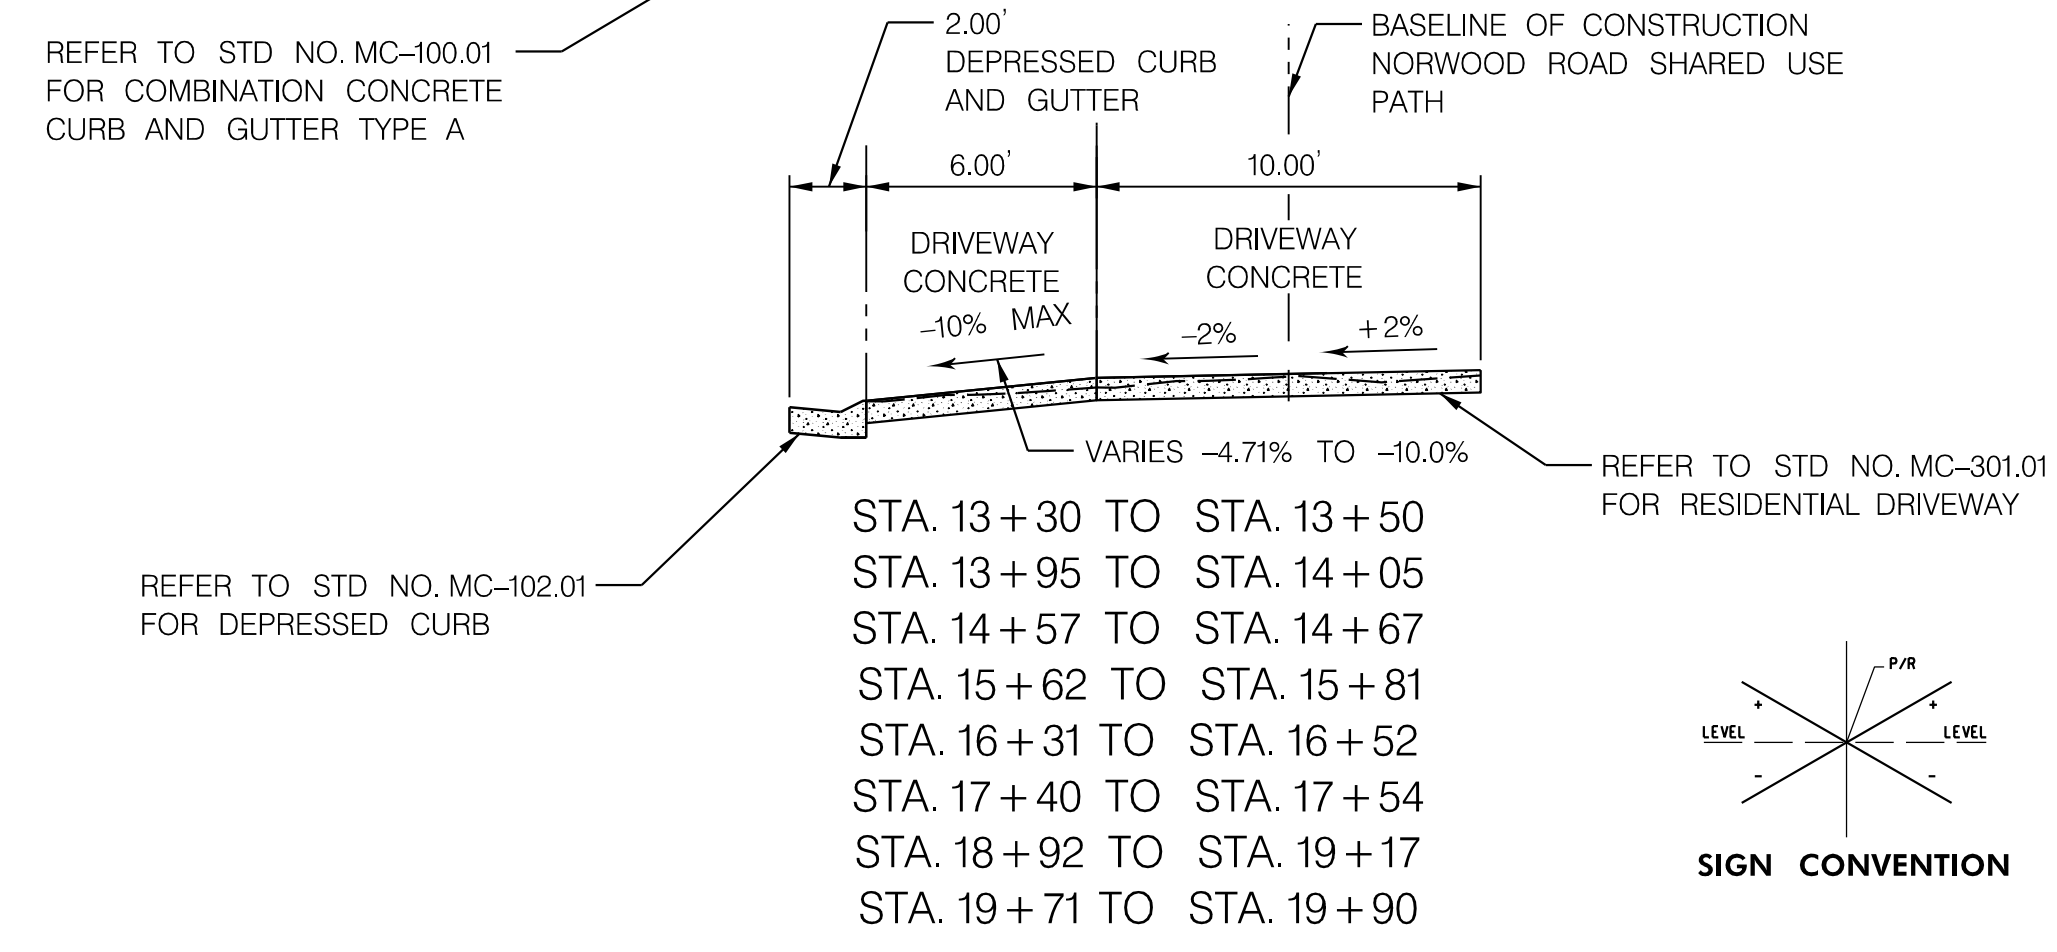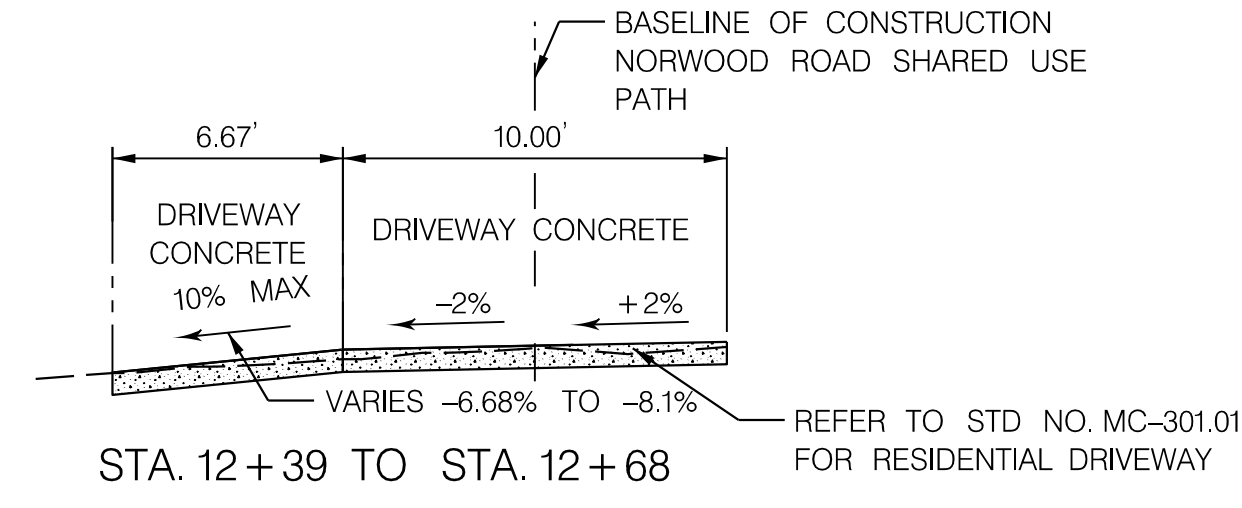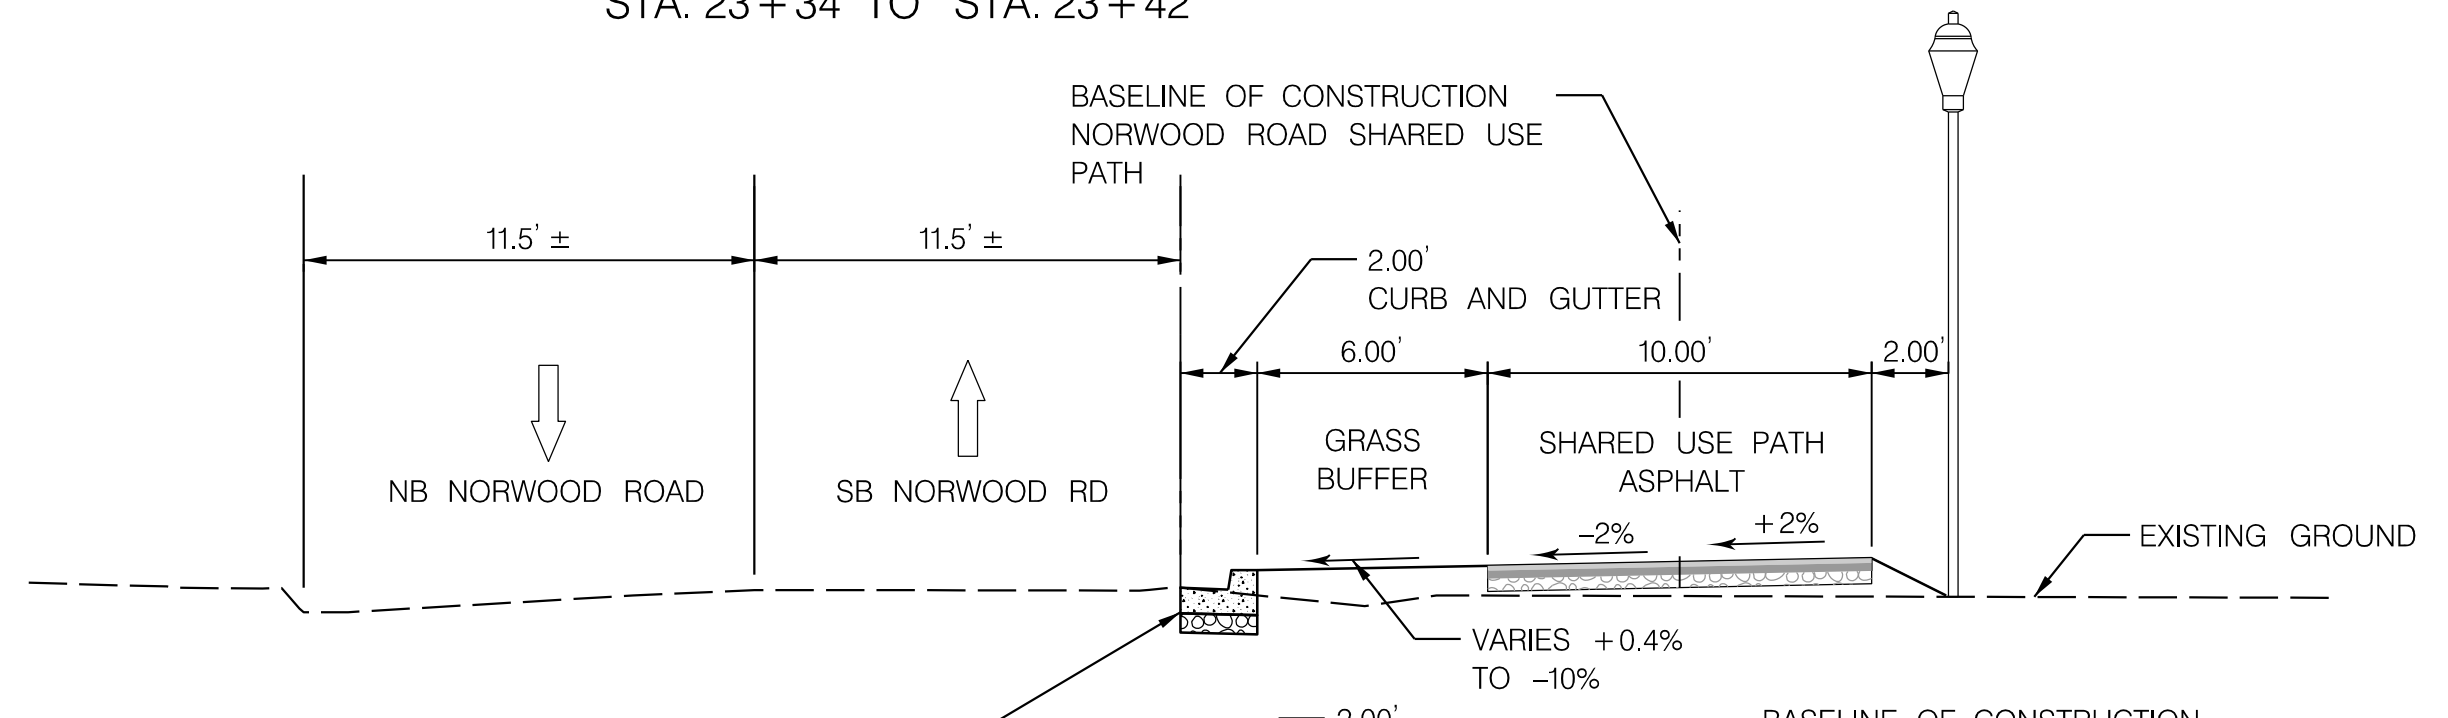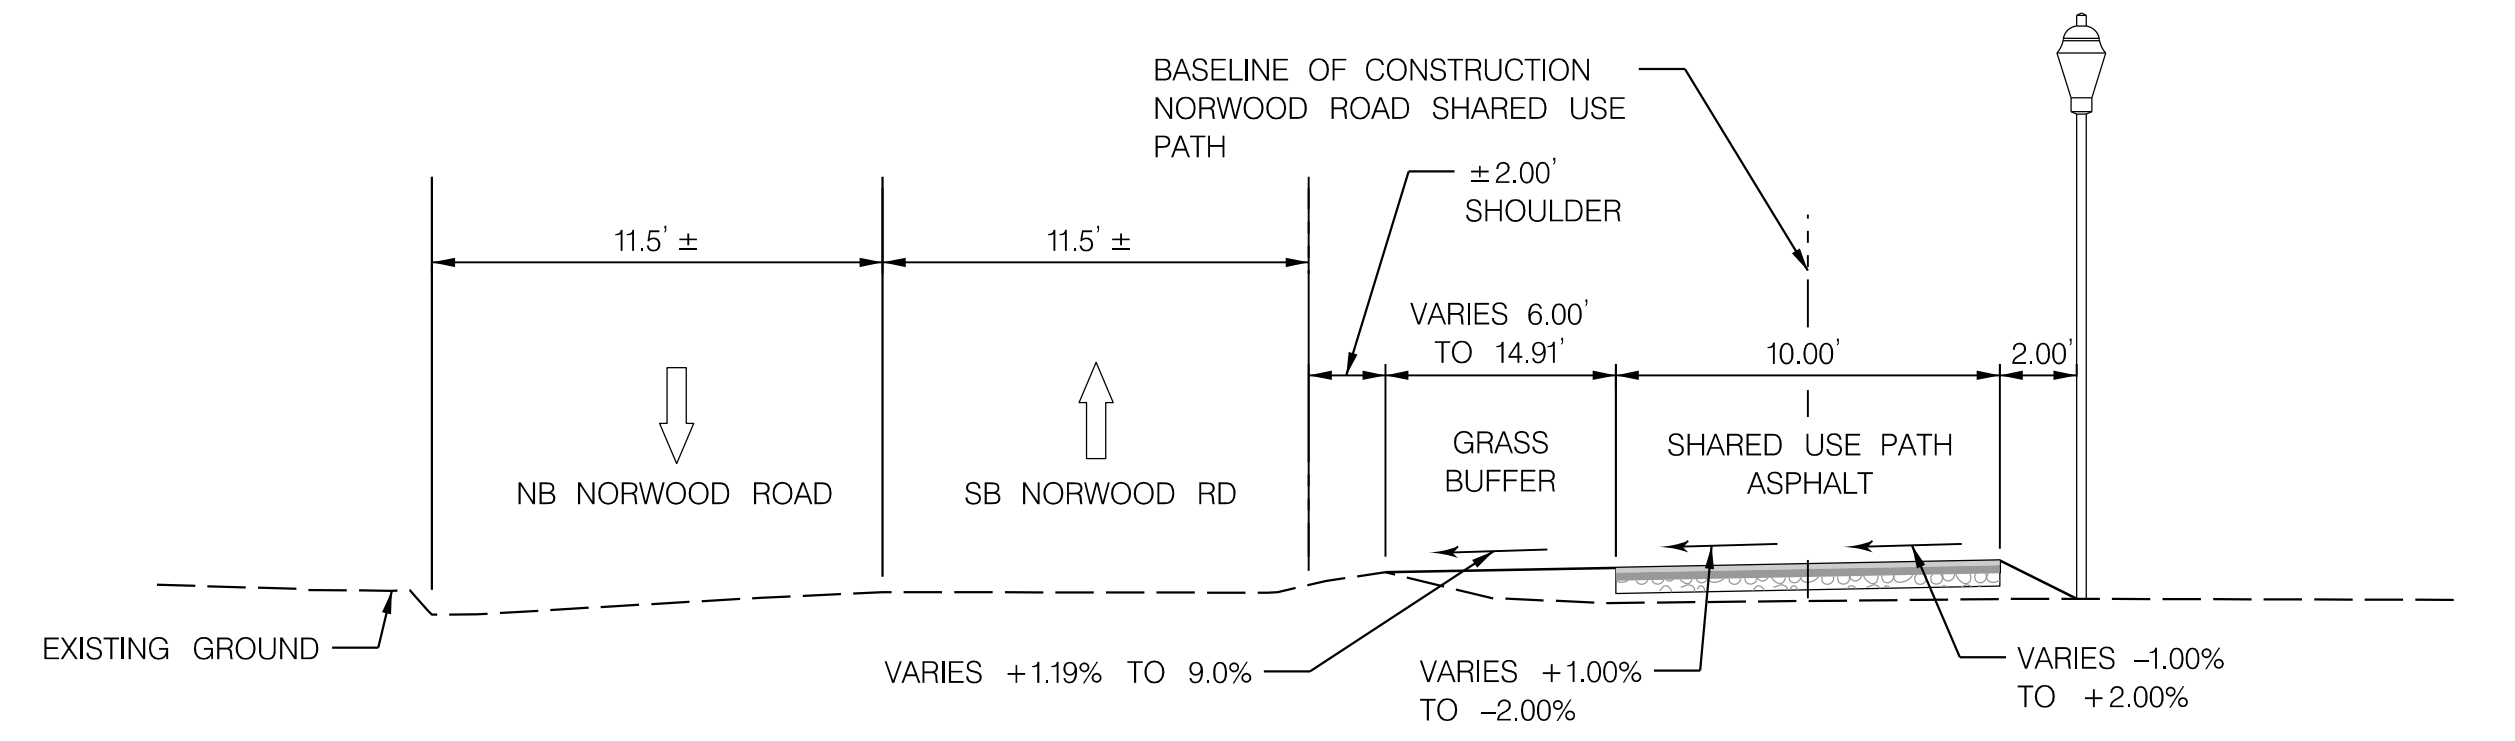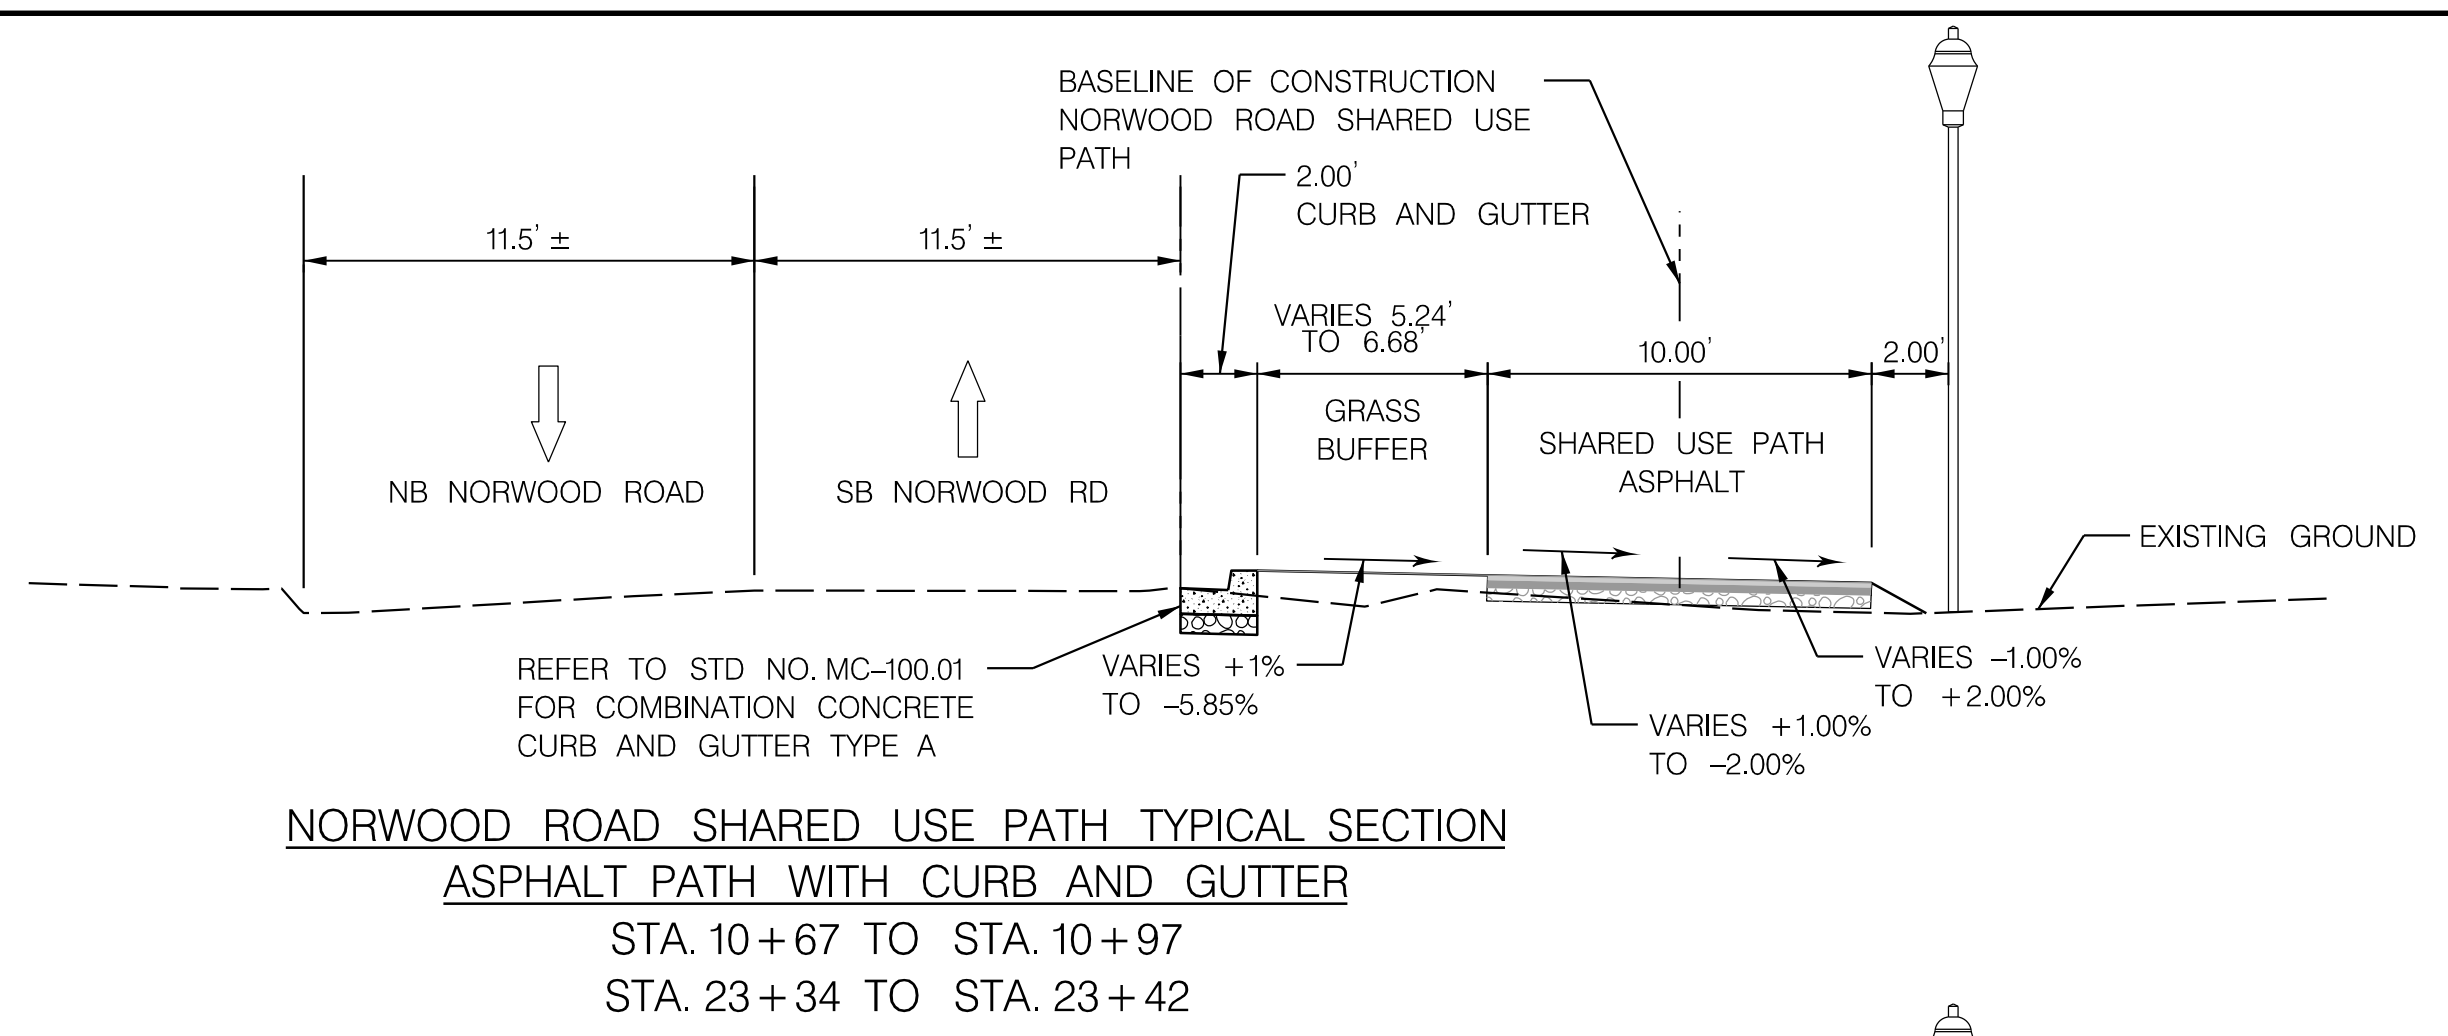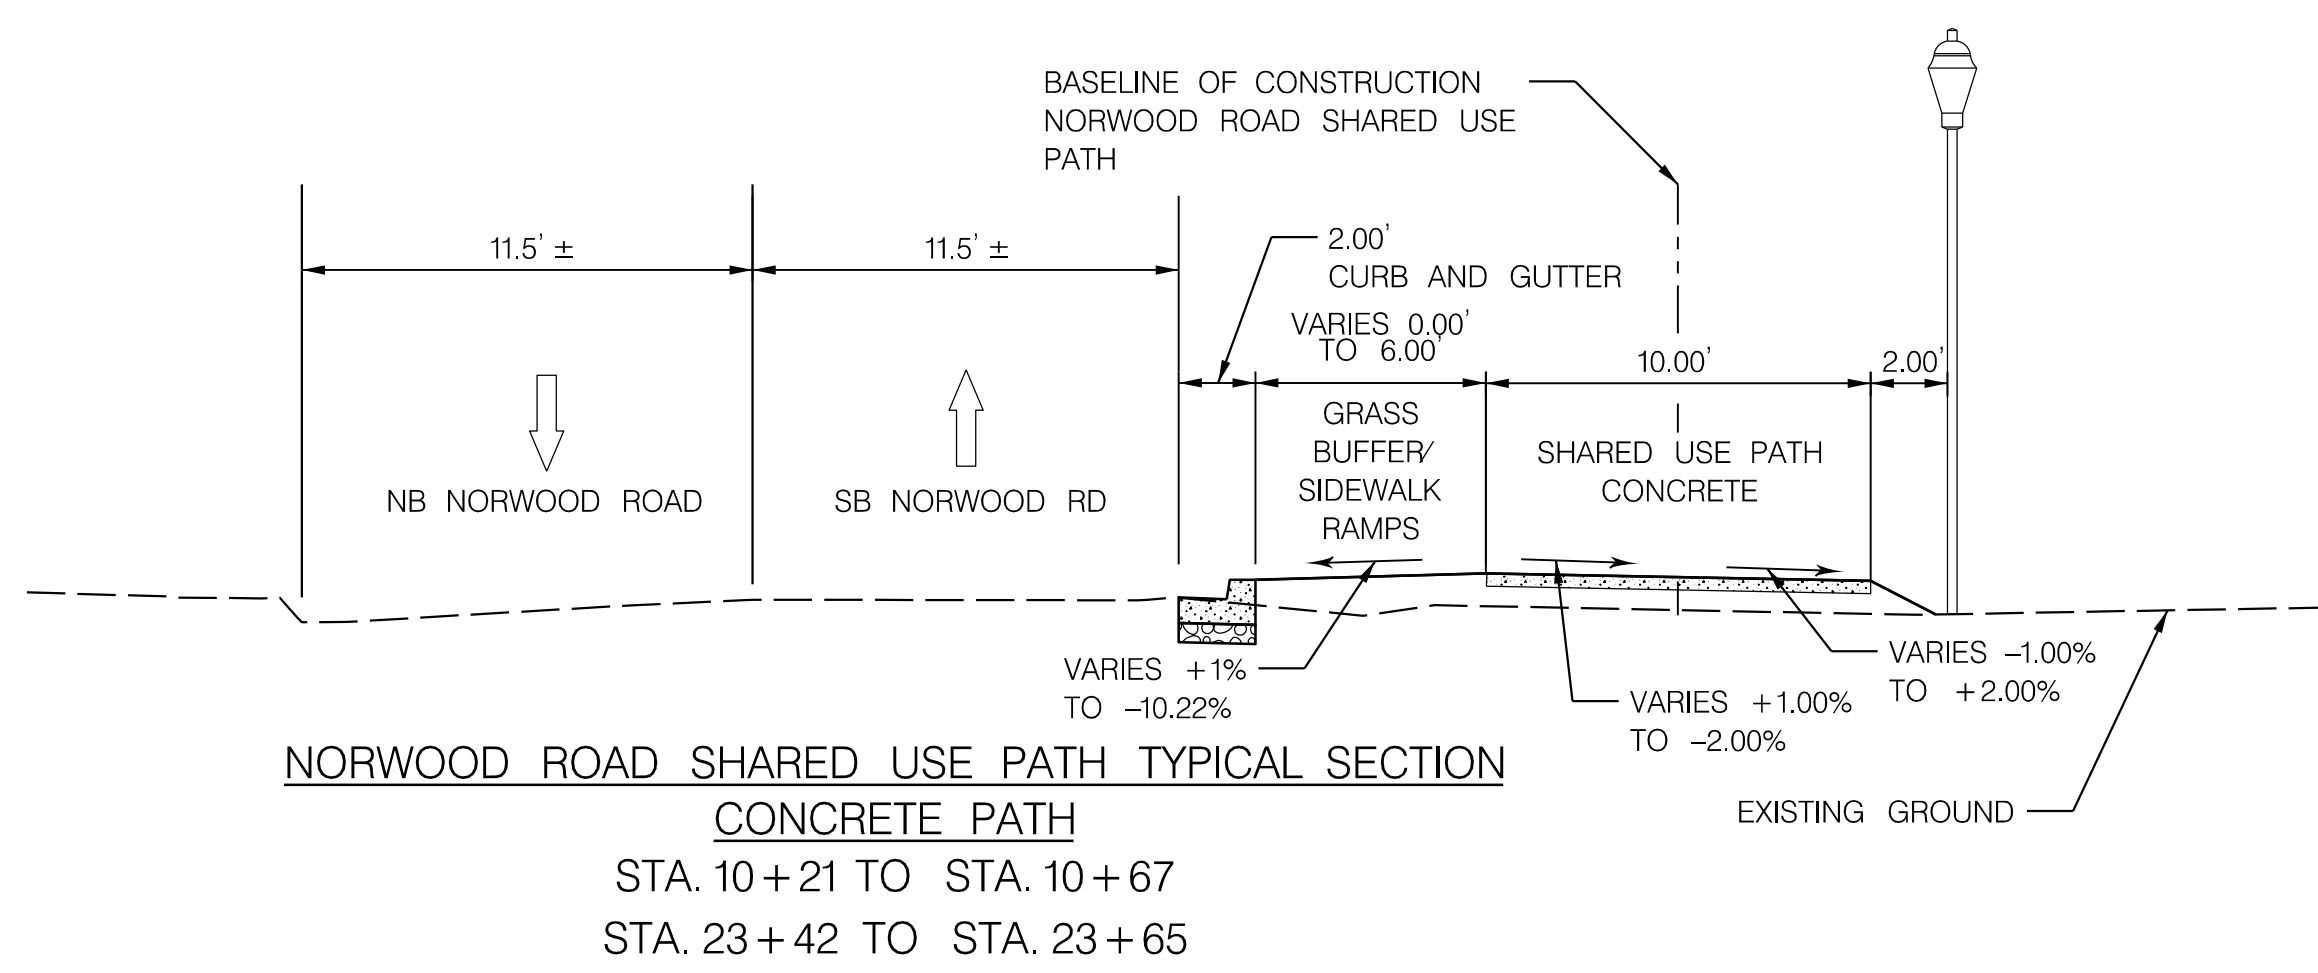


- PAVEMENT LEGEND**
- ① 1.5" BITUMINOUS CONCRETE SURFACE COURSE (ASPHALT)
 - ② 2.5" BITUMINOUS CONCRETE BASE COURSE (ASPHALT)
 - ③ 4" GRADED AGGREGATE BASE
 - ④ 4" CONCRETE FOR SIDEWALK
 - ⑤ 7" CONCRETE FOR DRIVEWAY

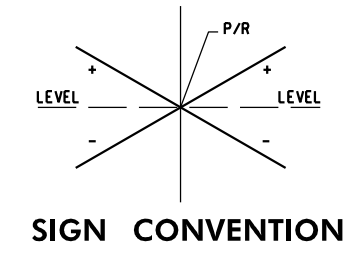



NORWOOD ROAD SHARED USE PATH TYPICAL SECTION ASPHALT PATH AND CONCRETE DRIVEWAY
 STA. 10+97 TO STA. 12+91
 STA. 20+26 TO STA. 23+34

NORWOOD ROAD SHARED USE PATH TYPICAL SECTION ASPHALT PATH AND CONCRETE DRIVEWAY WITH CURB AND GUTTER
 STA. 12+91 TO STA. 20+26

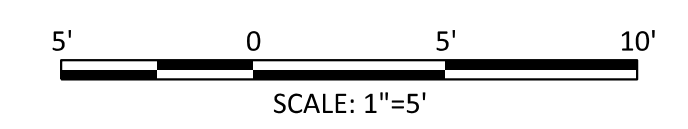

PLOTTER: 11x17s24s
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MONTGOMERY COUNTY DEPARTMENT OF TRANSPORTATION ROCKVILLE, MARYLAND				MONTGOMERY COUNTY DEPARTMENT OF TRANSPORTATION DIVISION OF TRANSPORTATION ENGINEERING NORWOOD ROAD SHARED USE PATH TYPICAL SECTIONS SCALE 1"=5' DATE NOVEMBER, 2023	
RECOMMENDED FOR APPROVAL Chief, Transportation Planning and Design Section Date _____ APPROVED Chief, Division of Transportation Engineering Date _____				DESIGNED BY <u>RA</u> DRAWN BY <u>NM</u> CHECKED BY <u>MWM</u>	
NO.	REVISION	DATE	BY	SHEET NO. <u>3</u> OF <u>20</u>	

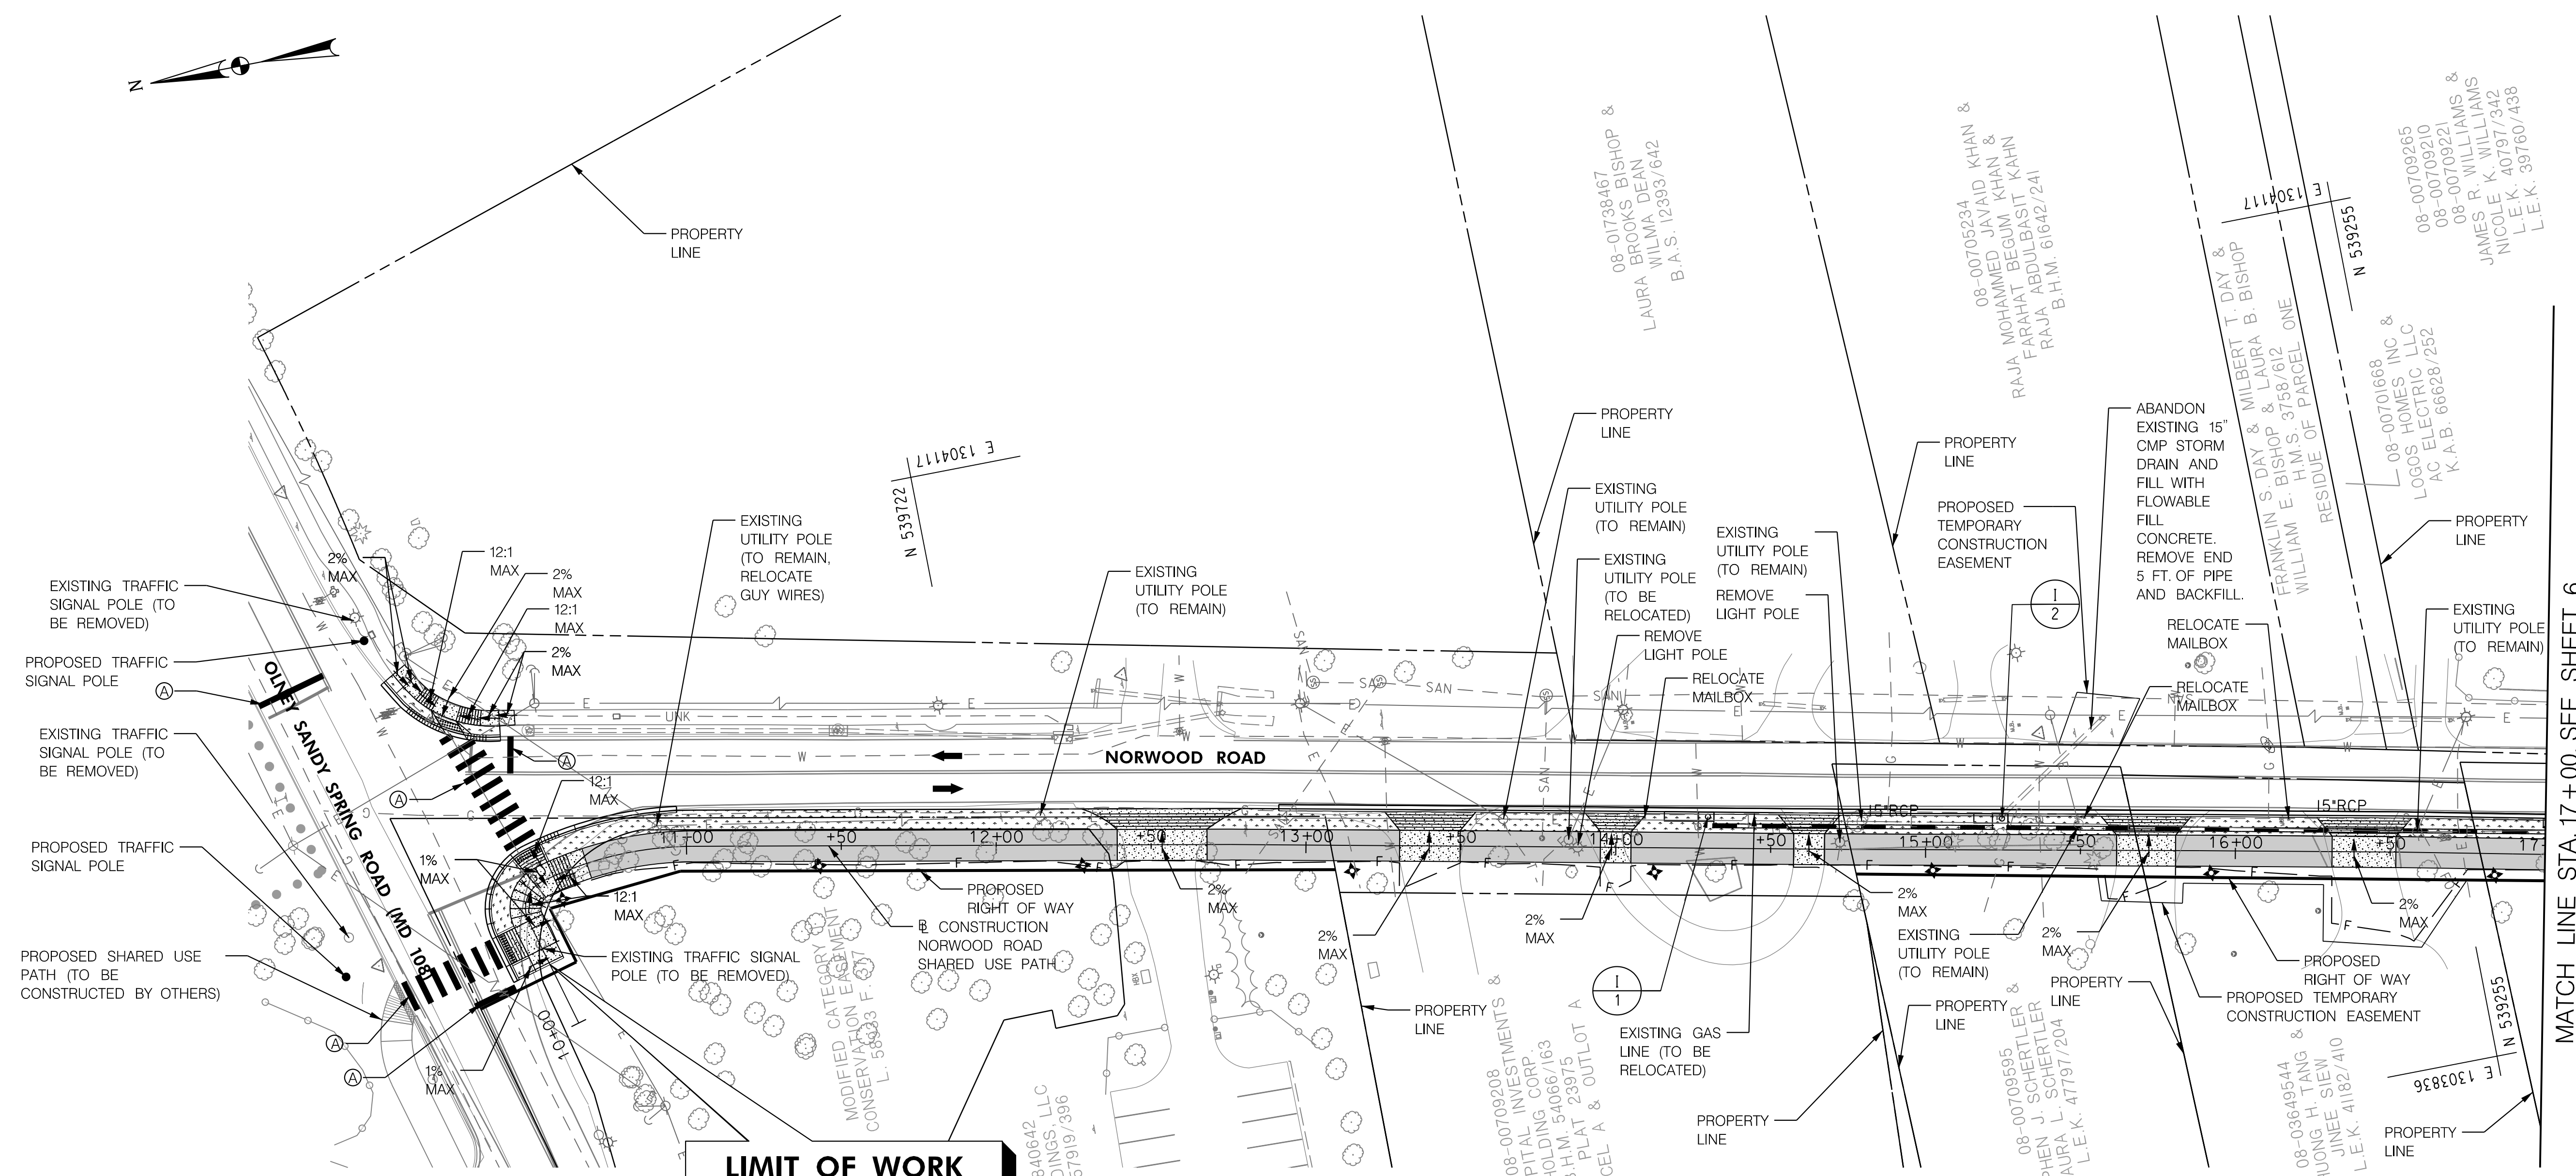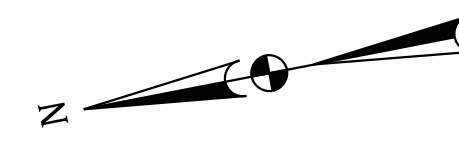

LIMIT OF WORK
CONTRACT NO. 502313
SHARED USE PATH
STA. 10+21

SHARED USE PATH PLAN
 SCALE: 1" = 30'

MATCH LINE STA. 17+00, SEE SHEET 6


LEGEND

- CONCRETE DRIVEWAY
- ASPHALT SHARED USE PATH
- GRASS BUFFER
- CLASS I RIPRAP
- DETECTABLE WARNING SURFACE
- CUT/FILL LINE
- PROPOSED LIGHT POLE
- EX. RIGHT OF WAY OR PROPERTY LINE
- PROPOSED RIGHT OF WAY
- EASEMENT
- 24 INCH WHITE THERMOPLASTIC PAVEMENT MARKINGS (SOLID)

TYPE A COMBINATION CURB AND GUTTER ANY HEIGHT OR DEPTH (STD MC-100.01)	
100	LF NORWOOD ROAD - STA. 10+21 TO STA. 10+97, LT
35	LF NORWOOD ROAD - STA. 10+50, 72 FT LT TO STA. 10+52, 47 FT LT
409	LF NORWOOD ROAD - STA. 12+91 TO STA. 17+00, LT



TYPE A CURB ANY HEIGHT OR DEPTH	
18	LF NORWOOD ROAD - STA. 10+21
6	LF NORWOOD ROAD - STA. 10+26
6	LF NORWOOD ROAD - STA. 10+37
6	LF NORWOOD ROAD - STA. 10+49
6	LF NORWOOD ROAD - STA. 10+56

4 INCH CONCRETE SIDEWALK (STD MC-112.01)	
567	SF NORWOOD ROAD - STA. 10+21 TO STA. 10+67, LT
163	SF NORWOOD ROAD - STA. 10+50, 73 FT LT TO STA. 10+60, 56 FT LT

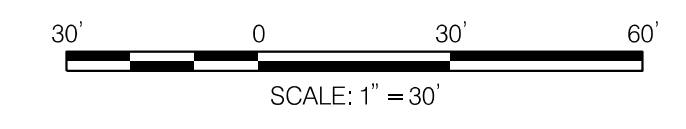

PLOT FILE: 11/02/2023
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	MONTGOMERY COUNTY DEPARTMENT OF TRANSPORTATION ROCKVILLE, MARYLAND	MONTGOMERY COUNTY DEPARTMENT OF TRANSPORTATION DIVISION OF TRANSPORTATION ENGINEERING NORWOOD ROAD SHARED USE PATH																
	RECOMMENDED FOR APPROVAL Chief, Transportation Planning and Design Section _____ Date _____ APPROVED Chief, Division of Transportation Engineering _____ Date _____	SHARED USE PATH PLAN-1 SCALE 1"=30' DATE NOVEMBER, 2023																
<table border="1" style="width: 100%; border-collapse: collapse;"> <thead> <tr> <th>NO.</th> <th>REVISION</th> <th>DATE</th> <th>BY</th> </tr> </thead> <tbody> <tr><td> </td><td> </td><td> </td><td> </td></tr> <tr><td> </td><td> </td><td> </td><td> </td></tr> <tr><td> </td><td> </td><td> </td><td> </td></tr> </tbody> </table>	NO.	REVISION	DATE	BY													DESIGNED BY <u>RA</u> DRAWN BY <u>NM</u> CHECKED BY <u>MWM</u>	SHEET NO. <u>5</u> OF <u>20</u>
NO.	REVISION	DATE	BY															

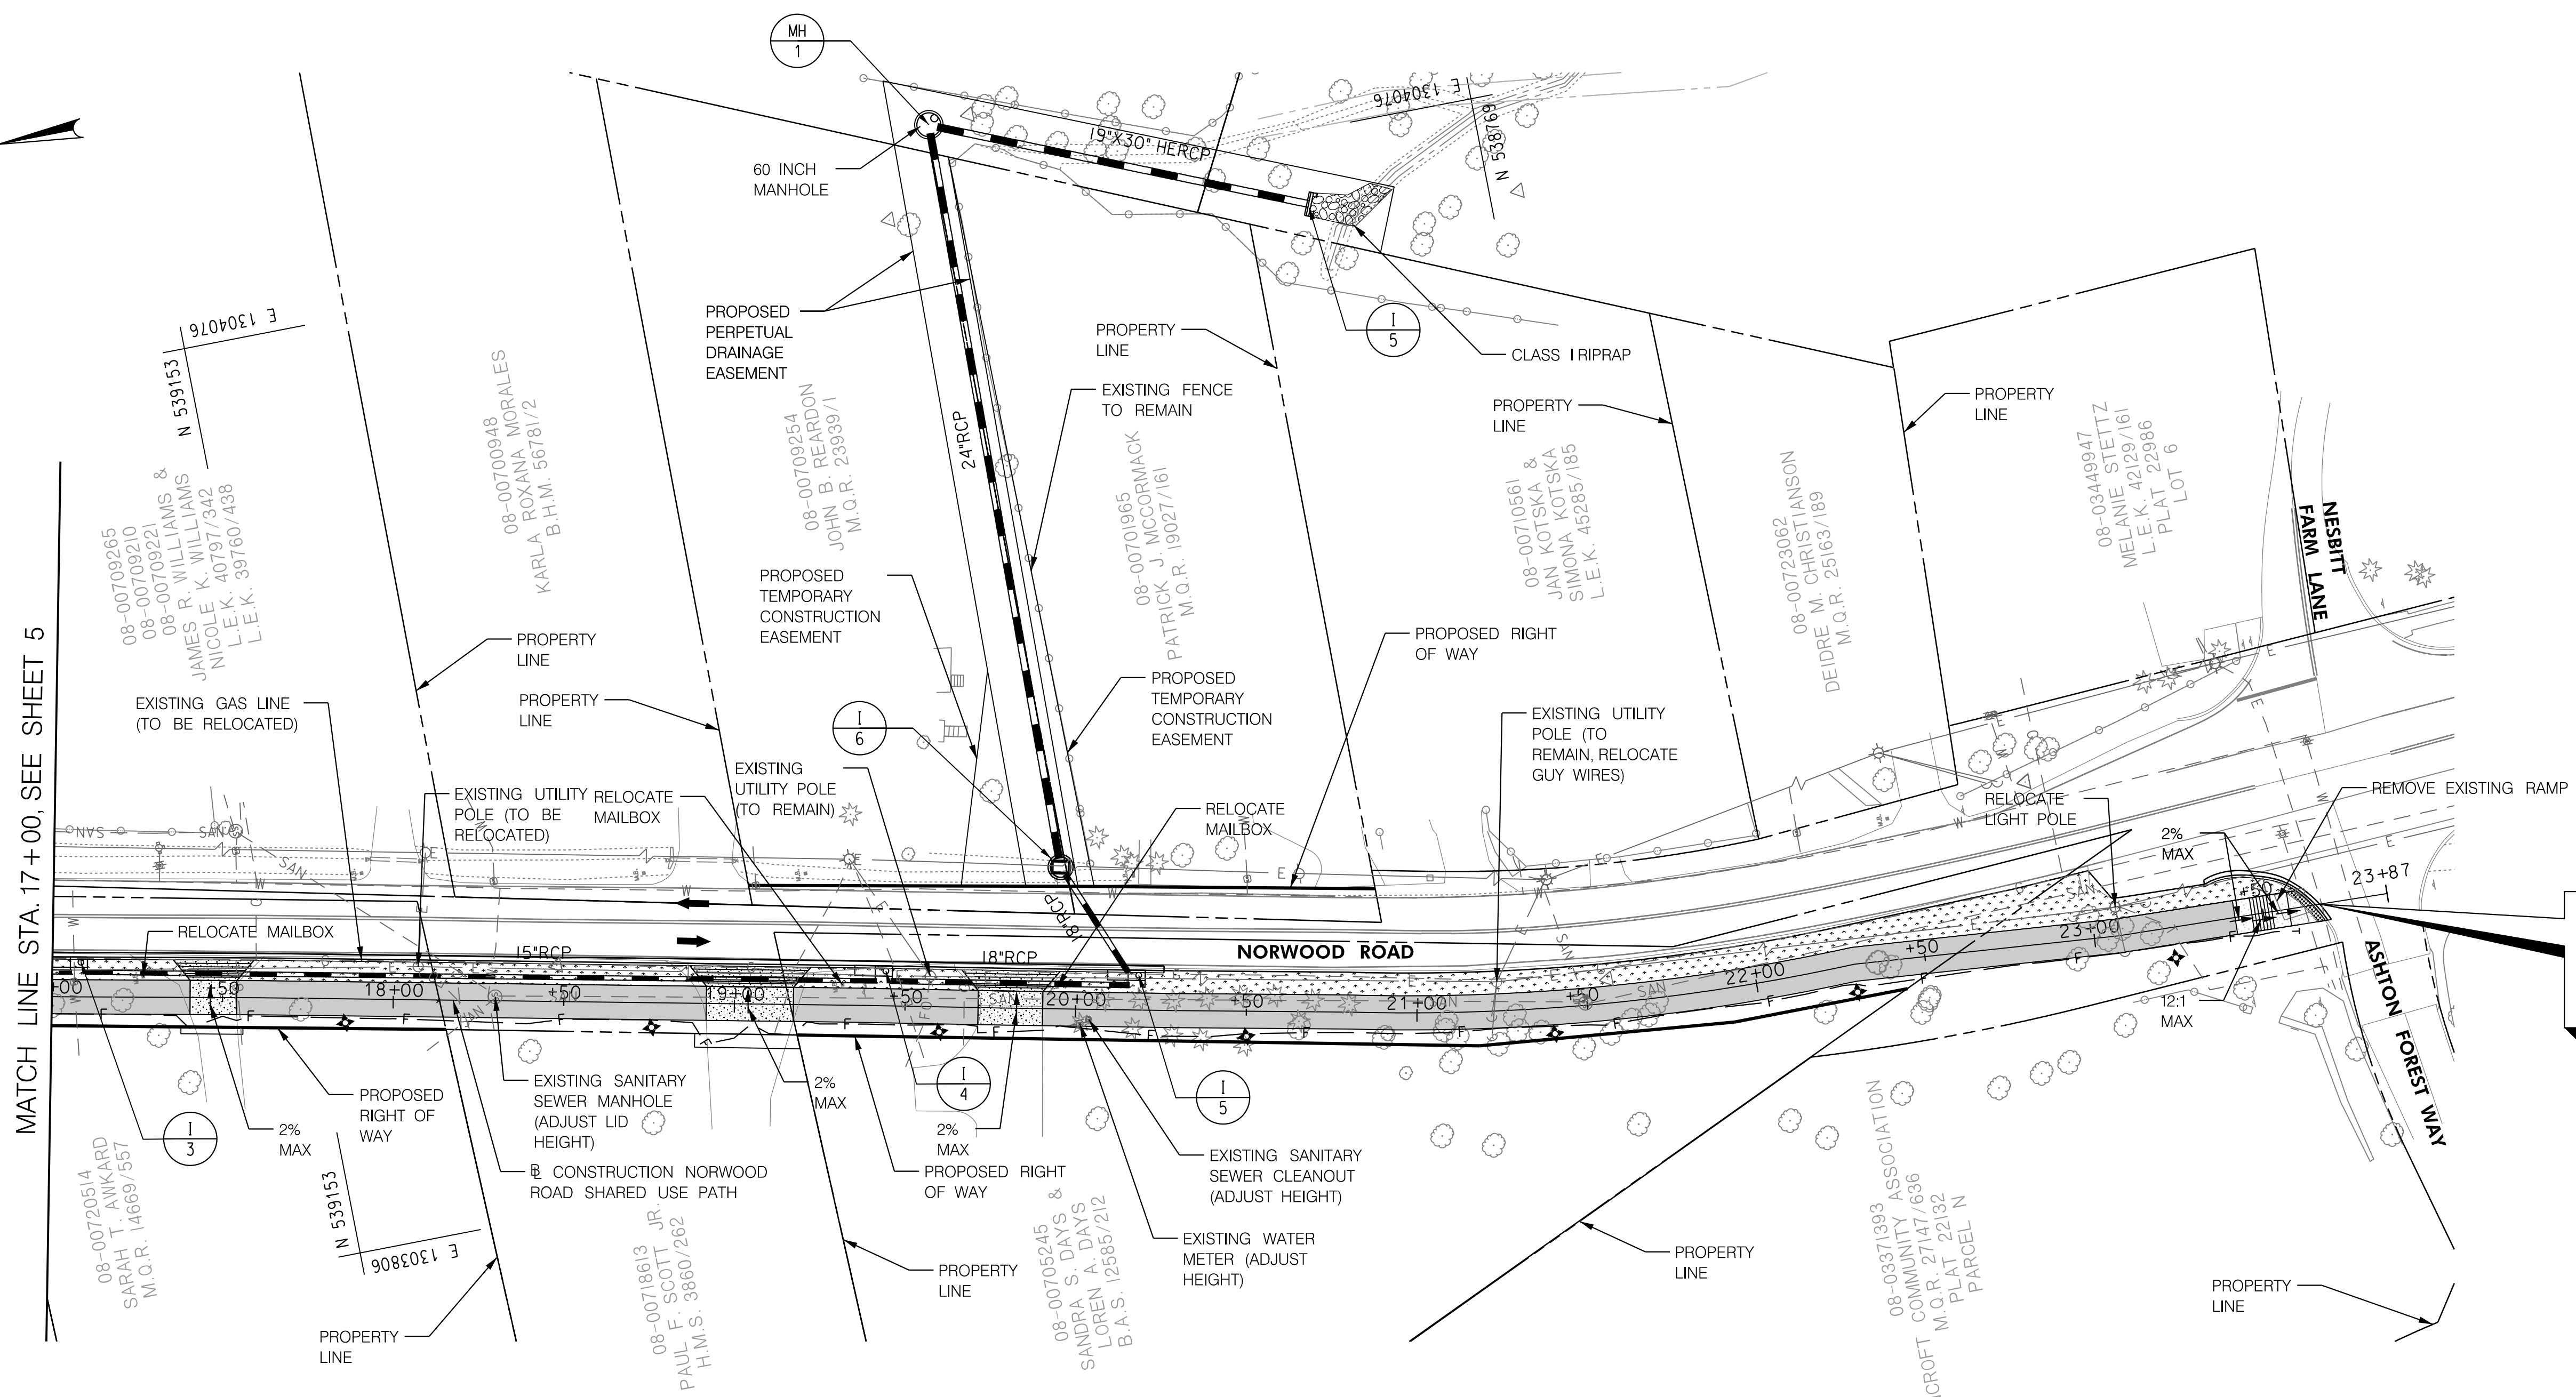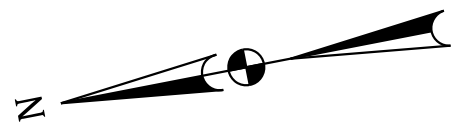

LIMIT OF WORK
CONTRACT NO. 502313
SHARED USE PATH
STA. 23+67

SHARED USE PATH PLAN
 SCALE: 1" = 30'

- LEGEND**
- CONCRETE DRIVEWAY
 - ASPHALT SHARED USE PATH
 - GRASS BUFFER
 - CLASS I RIPRAP
 - DETECTABLE WARNING SURFACE
 - CUTFILL LINE
 - PROPOSED LIGHT POLE
 - EX. RIGHT OF WAY OR PROPERTY LINE
 - PROPOSED RIGHT OF WAY
 - EASEMENT
 - 24 INCH WHITE THERMOPLASTIC PAVEMENT MARKINGS (SOLID)


TYPE A COMBINATION CURB AND GUTTER ANY HEIGHT OR DEPTH	
326	LF NORWOOD ROAD - STA. 17+00 TO STA. 20+26, LT
43	LF NORWOOD ROAD - STA. 23+34 TO STA. 23+69, LT
4 INCH CONCRETE SIDEWALK (STD MC-112.01)	
163	SF NORWOOD ROAD - STA. 23+42 TO STA. 23+65, LT



PLOTED: 11/20/2023
 FILE: \\lvsrv01\projects\1908\1908.dwg (Spring Blkway) (05 Roadway) (CADD) (4-PAGE) (Norwood)


MONTGOMERY COUNTY DEPARTMENT OF TRANSPORTATION ROCKVILLE, MARYLAND			
RECOMMENDED FOR APPROVAL			
Chief, Transportation Planning and Design Section		Date	
APPROVED			
Chief, Division of Transportation Engineering		Date	
DESIGNED BY	RA	DRAWN BY	NM
CHECKED BY	MWM		

MONTGOMERY COUNTY DEPARTMENT OF TRANSPORTATION DIVISION OF TRANSPORTATION ENGINEERING	
NORWOOD ROAD SHARED USE PATH	
SHARED USE PATH PLAN-2	
SCALE 1"=30'	DATE NOVEMBER, 2023
SHEET NO. 6 OF 20	

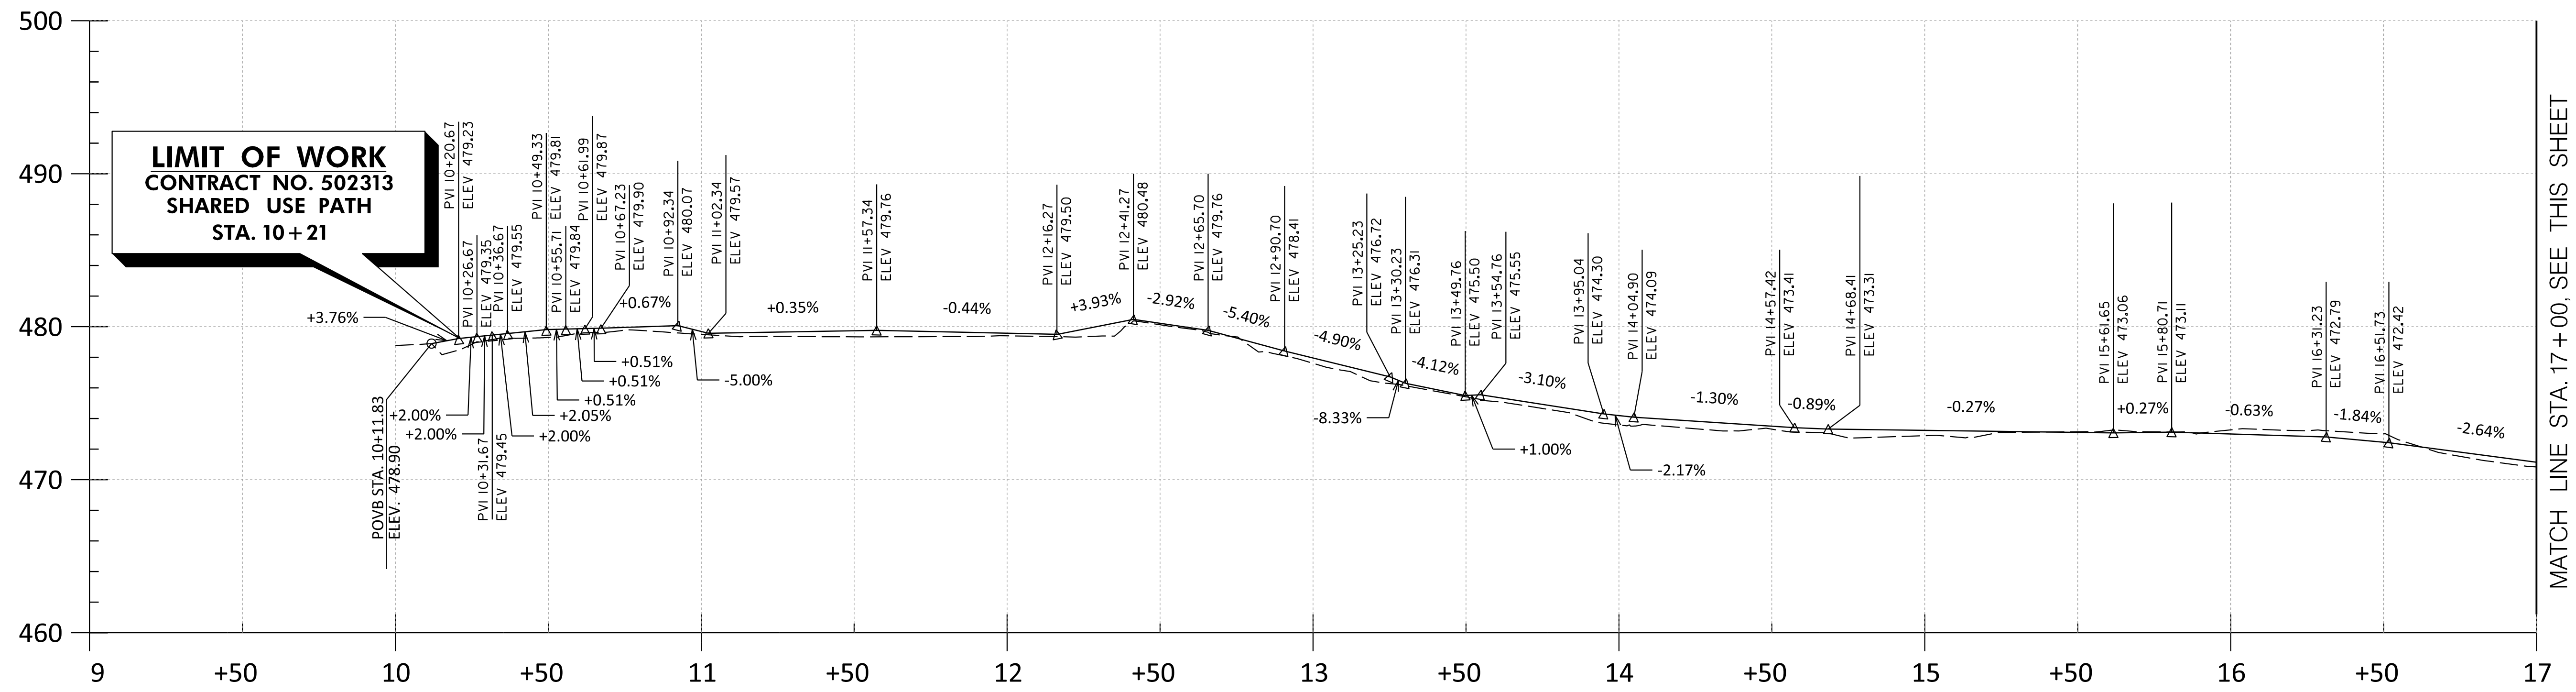

LIMIT OF WORK
CONTRACT NO. 502313
SHARED USE PATH
STA. 10+21


MATCH LINE STA. 17+00, SEE THIS SHEET

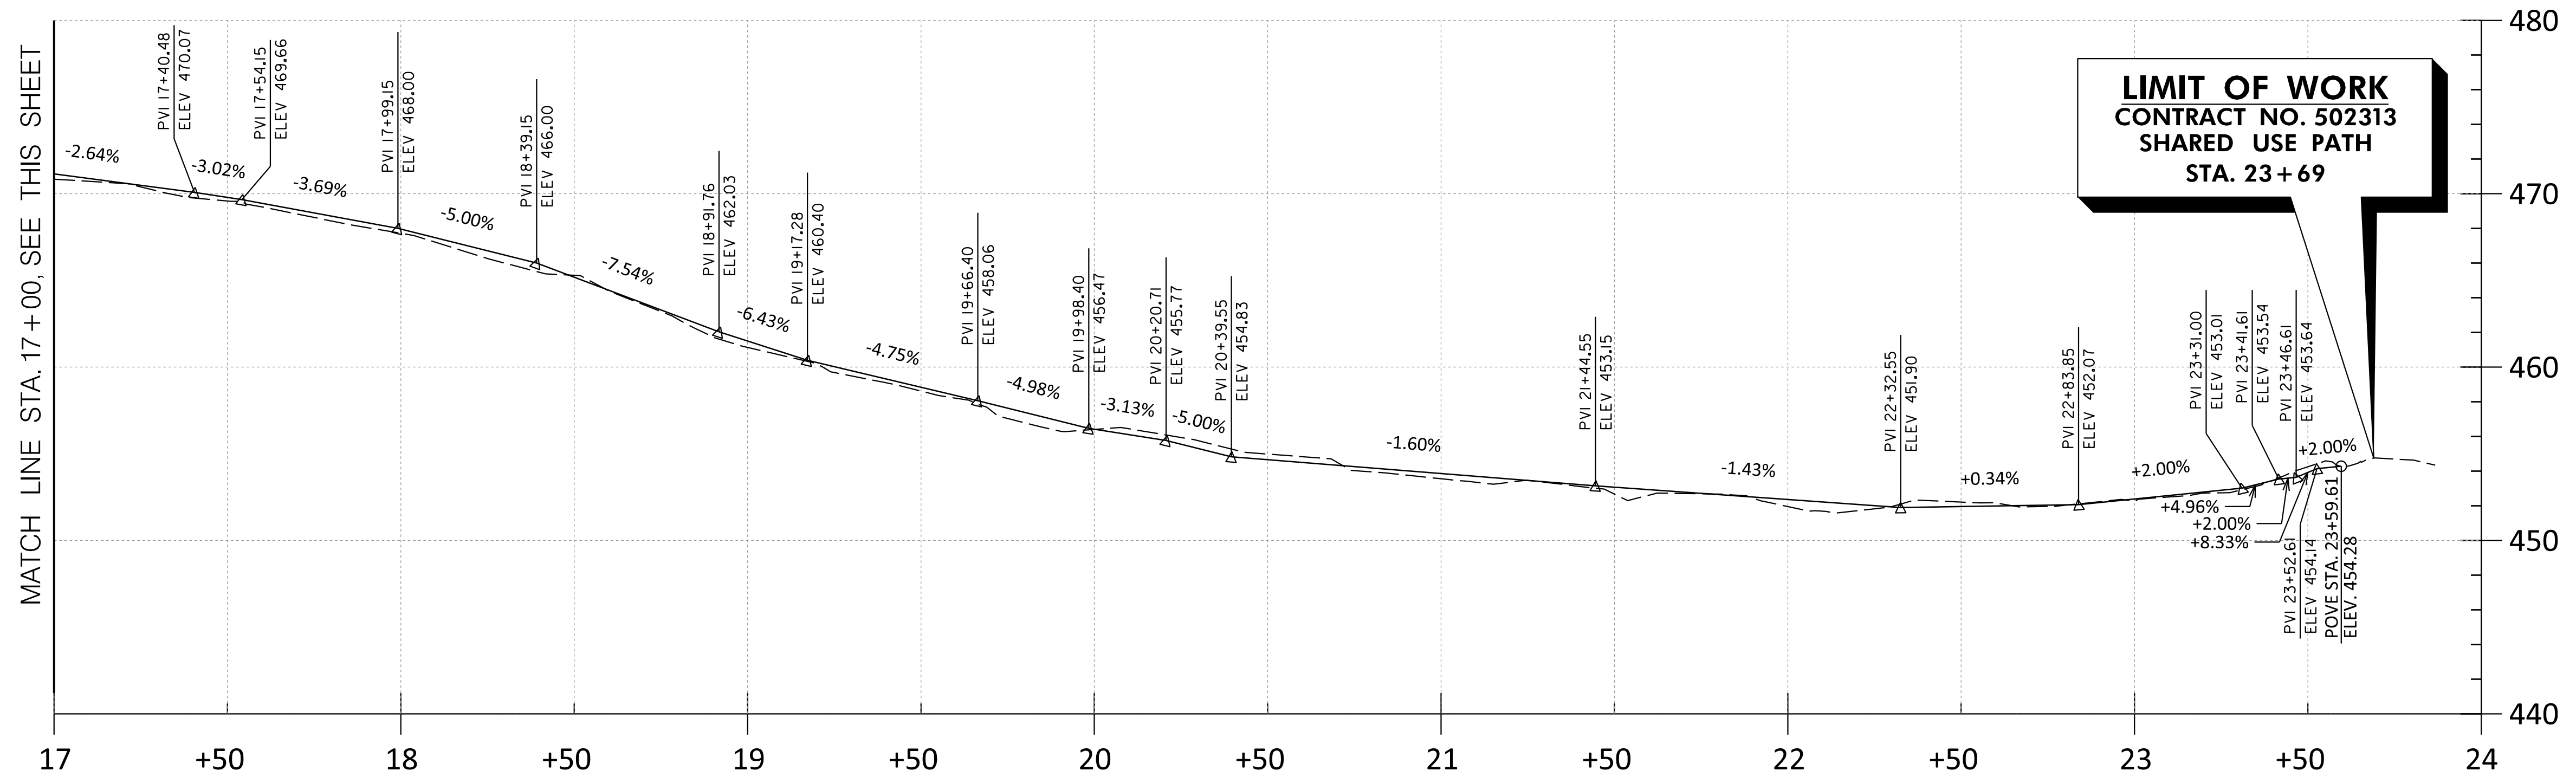

LIMIT OF WORK
CONTRACT NO. 502313
SHARED USE PATH
STA. 23+69

MATCH LINE STA. 17+00, SEE THIS SHEET

ROADWAY PROFILE
 HORIZONTAL: 1" = 30'
 VERTICAL: 1" = 6'

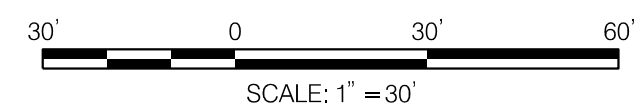

PLOTTED: 11/16/2023
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				MONTGOMERY COUNTY DEPARTMENT OF TRANSPORTATION ROCKVILLE, MARYLAND		MONTGOMERY COUNTY DEPARTMENT OF TRANSPORTATION DIVISION OF TRANSPORTATION ENGINEERING	
				RECOMMENDED FOR APPROVAL		NORWOOD ROAD SHARED USE PATH	
				Chief, Transportation Planning and Design Section _____ Date _____		SHARED USE PATH PROFILES	
				APPROVED		HORIZONTAL: 1" = 30' SCALE VERTICAL: 1" = 5' DATE NOVEMBER, 2023	
				Chief, Division of Transportation Engineering _____ Date _____		DESIGNED BY_KBJ_ DRAWN BY_KBJ_ CHECKED BY_XXX_	
						SHEET NO. 7 OF 20	
NO.	REVISION	DATE	BY				

I. TRAFFIC CONTROL PLAN GENERAL REQUIREMENTS

- A. A PRIME REQUIREMENT OF THIS CONTRACT IS THAT TWO (2) WAY TRAFFIC BE MAINTAINED AT ALL TIMES ALONG NORWOOD ROAD, IN AN ORDERLY, EXPEDITIOUS AND SAFE MANNER UNLESS OTHERWISE NOTED IN THE PLANS. FLAGGER CONTROL SHALL BE UTILIZED AS A METHOD OF MAINTAINING ONE LANE TWO WAY TRAFFIC DURING WORKING HOURS. THE WIDTH OF ANY LANE SHALL REMAIN AT LEAST A MINIMUM OF NINE (9) FEET WIDE DURING NON-WORKING HOURS.
- B. UNLESS OTHERWISE APPROVED BY THE TRAFFIC ENGINEERING AND OPERATIONS SECTION, THE NUMBER OF LANES OF TRAFFIC ON NORWOOD ROAD SHOWN ON THE T.C.P. SHALL BE MAINTAINED DURING NON-WORKING HOURS.
- C. THE SEQUENCE OF OPERATIONS OF THE CONSTRUCTION REFERS SPECIFICALLY TO THE CRITICAL ITEMS OF WORK WHICH MUST BE COMPLETED. THE LISTED ITEMS ARE A SUGGESTED SEQUENCE OF WORK TO BE FOLLOWED TO PROVIDE FOR ORDERLY COMPLETION OF WORK. THE MANY OTHER ITEMS OF WORK WHICH ARE NOT LISTED AND WHICH MAY BE PERFORMED WITHOUT INTERRUPTING TRAFFIC OR AFFECTING THE CONSTRUCTION SCHEDULING AND DO NOT CONTROL THE OVERALL SCHEDULE FOR COMPLETING THE PROJECT ARE NOT LISTED.
- D. ALL SIDEWALK CLOSURES SHALL REQUIRE THE APPROVAL OF DIVISION OF TRAFFIC ENGINEERING AND OPERATIONS. ANY SIDEWALK CLOSURE GREATER THAN TWO (2) WEEKS SHALL REQUIRE THE SUBMITTAL OF A WRITTEN REQUEST TO THE DIVISION OF TRAFFIC ENGINEERING AND OPERATIONS AND MAY REQUIRE ADDITIONAL TRAFFIC CONTROLS. SIDEWALK CLOSURES SHALL BE LIMITED TO OCCUR ONLY DURING THE ACTUAL WORK ACTIVITY. DURING CLOSURE, SIDEWALKS SHALL BE BARRICADED TO PHYSICALLY PREVENT PEDESTRIAN PASSAGE AND APPROPRIATE DETOURS SHALL BE POSTED. DURING ALL OTHER TIMES, PROVISIONS FOR SAFE PEDESTRIAN ACCESS THROUGH THE WORK AREA, VIA A TEMPORARY WALKWAY SHALL BE PROVIDED.
- E. ANY WORK WITHIN THE TRAVELED PORTION OF THE ROADWAY WILL BE RESTRICTED TO THE HOURS OF 9:00 A.M. TO 3:30 P.M., MONDAY THRU FRIDAY. NO WORK ON HOLIDAYS OR WEEKENDS UNLESS WRITTEN EXCEPTION IS GRANTED IN WRITING BY THE COUNTY'S DPS INSPECTOR.
- F. CONSTRUCTION ACTIVITY, LOADING OR UNLOADING OF EQUIPMENT SHALL NOT BLOCK ANY TRAFFIC LANE OTHER THAN THOSE DELINEATED WITHIN THE WORK ZONE.
- G. EXCLUSIVE OF EMERGENCY WORK, THE CONTRACTOR SHALL CONTACT OCCUPANTS OF ALL ADJOINING PROPERTIES AND INFORM THEM OF THE SCOPE AND THE TIMING OF CONSTRUCTION. A MINIMUM OF 24 HOURS NOTIFICATION SHALL BE REQUIRED PRIOR TO THE COMMENCEMENT OF ANY ACTIVITY ON THE SITE.
- H. ACCESS SHALL BE MAINTAINED TO ALL DRIVEWAYS UNLESS PERMISSION FOR CLOSURE IS GRANTED BY THE PROPERTY OWNER/MANAGER. HOWEVER, ACCESSIBILITY FOR EMERGENCY VEHICLES SHALL BE MAINTAINED AT ALL TIMES.
- I. IF ANY TRAFFIC CONTROL SIGNS ARE TO BE PLACED ALONG A MDT SHA ROADWAY, OR WITHIN THE LIMITS OF AN INCORPORATED AREAS, THE PERMITTEE SHALL NOTIFY THE APPROPRIATE AGENCY OF SIGNAGE TO BE INSTALLED.
- J. NO HAZARDOUS MATERIALS SHALL BE STORED WITHIN PUBLIC RIGHT-OF-WAY. NO MATERIALS OR EQUIPMENT SHALL BE STORED ON THE ROADWAY SURFACE OR SIDEWALK DURING NON-WORK PERIODS. ALL STORED MATERIALS AND EQUIPMENT SHALL BE SET BACK AT LEAST SIX (6) FEET BEHIND THE CURB ALONG A CLOSED SECTION ROADWAY AND AT LEAST TWELVE (12) FEET FROM EDGE OF OPEN SECTION ROADWAY.
- K. ANY EXCAVATION(S) IN THE ROADWAY SHALL BE PAVED TO LEVEL GRADE OR PLATED AND THE ROADWAY REOPENED TO ITS FULL CROSS-SECTION PRIOR TO THE END OF EACH WORK DAY. "STEEL PLATES AHEAD" (W21-9) SIGNS SHALL BE PLACED APPROXIMATELY 250 FEET IN ADVANCE OF ANY STEEL PLATE. ANY EXCAVATIONS IN THE SIDEWALK SHALL BE BACKFILLED OR PLATED PRIOR TO THE END OF EACH WORKDAY AND SIDEWALK REOPENED TO ITS FULL CROSS SECTION.

- L. TRAFFIC SHALL NOT BE PERMITTED WITHIN TEN (10) FEET OF ANY EXCAVATION THAT RESULTS IN A VERTICAL DROP-OFF OF MORE THAN FIVE (5) INCHES IN THE LEVEL OF PAVEMENT DURING NON-WORKING HOURS UNLESS PROTECTED BY TEMPORARY CONCRETE BARRIERS OR RAMPED WITH AGGREGATE MATERIAL AT A 3:1 OR FLATTER SLOPE FROM THE EDGE OF PAVEMENT. WHEN RAMPING IS UTILIZED, TTC DRUMS SHALL BE POSITIONED ADJACENT TO THE EDGE OF THE WORK AREA ON THE TRAFFIC SIDE OF THE SLOPE. REFER TO MCDOT STD NO. TCP-108.01 FOR DETAILS.
- M. TRAFFIC SHALL NOT BE PERMITTED WITHIN TWO (2) FEET OF ANY EXCAVATION THAT RESULTS IN A VERTICAL DROP-OFF OF MORE THAN TWO (2) INCHES BUT NO MORE THAN FIVE (5) INCHES IN THE LEVEL OF PAVEMENT DURING NON-WORKING HOURS UNLESS EITHER RAMPED WITH AGGREGATE MATERIAL AT 3:1 OR FLATTER SLOPE, PROVIDED WITH AN ABUTTING WEDGE OF BITUMINOUS MATERIAL AT 3:1 OR FLATTER SLOPE OR PROTECTED BY TRAFFIC DRUMS.
- N. IN AREAS WHERE A DROP-OFF IN THE LEVEL OF PAVEMENT IS TWO (2) INCHES OR LESS, TRAFFIC MAY BE ALLOWED TO FREELY CROSS UNDER THE FOLLOWING CONDITIONS:
 - 1. WHERE LONGITUDINAL PAVING JOINTS OF TWO (2) INCHES OR LESS ARE EXPOSED TO TRAFFIC, WARNING SIGNS SHALL BE POSTED INDICATING "UNEVEN PAVEMENT" (W8-II MOD.). THESE SIGNS SHOULD BE PLACED 250 FEET IN ADVANCE OF THE UNEVEN JOINT AND BE SPACED AT APPROPRIATE INTERVALS THROUGHOUT THE AREA OF THE UNEVEN JOINT.
 - 2. WHERE LATERAL PAVING JOINTS OF TWO (2) INCHES OR LESS ARE EXPOSED TO TRAFFIC, A "BUMP" (W8-I) SIGN SHALL BE POSTED 100 FEET IN ADVANCE OF THE JOINT.
 - 3. WHEN MILLED PAVEMENT IS LEFT EXPOSED TO TRAFFIC, A "ROUGH ROAD (W8-8) OR "GROOVED PAVEMENT" (W8-8A) SIGN SHALL BE PLACED 250 FEET IN ADVANCE OF THE MILLED AREA.
- O. TEMPORARY TRAFFIC CONTROL SIGNS SHALL BE FLUORESCENT ORANGE HIGH PERFORMANCE WIDE ANGLE RETROREFLECTIVE SHEETING. PLACEMENT OF ALL SIGNS SHALL NOT INTERFERE WITH TRAVELED WAYS OR SIGHT DISTANCES OF ANY ROADWAY, STREET OR DRIVEWAY AS PER AASHTO POLICY ON GEOMETRIC DESIGN OF HIGHWAYS AND STREETS, LATEST EDITION.
- P. ALL EXISTING TRAFFIC CONTROL DEVICES THAT MUST BE REMOVED SHALL BE REPLACED IN THEIR PROPER LOCATION PRIOR TO THE COMPLETION OF THE PROJECT. COST FOR THE REPLACEMENT AND/OR REPAIR OF DEVICES DAMAGED AS A RESULT OF THE PROJECT SHALL BE ASSESSED TO THE CONTRACTOR.
- Q. ALL TRAFFIC CONTROL DEVICES SHALL CONFORM TO THE MOST RECENT EDITION OF THE MANUAL ON UNIFORM TRAFFIC CONTROL DEVICES (MUTCD).
- R. THE IMPLEMENTATION DATE AND CONTINUANCE OF THIS PROJECT MAY BE ALTERED AT THE DISCRETION OF THE COUNTY'S INSPECTOR IN THE EVENT OF CONFLICTS WITH PREVIOUSLY APPROVED OR EMERGENCY ACTIVITIES.
- S. AT THE COMPLETION OF THE PERMITTED WORK ACTIVITY, CONDITIONS WITHIN THE PUBLIC SPACE SHALL BE FULLY RESTORED TO THOSE WHICH EXISTED PRIOR TO THE WORK ACTIVITY.
- T. THE CONTRACTOR SHALL BE RESPONSIBLE FOR MAINTAINING ALL TEMPORARY TRAFFIC CONTROL DEVICES AT THE SITE.
- U. ANY CHANGES TO TEMPORARY TRAFFIC CONTROL PLANS SHALL BE MADE IN WRITING AND APPROVED BY THE MONTGOMERY COUNTY TRAFFIC ENGINEERING AND OPERATIONS DIVISION.
- V. ALL TTC DEVICES SHALL BE REMOVED AS SOON AS PRACTICAL WHEN THEY ARE NO LONGER NEEDED. WHEN WORK IS SUSPENDED FOR SHORT PERIODS OF TIME, TTC DEVICES THAT ARE NO LONGER APPROPRIATE SHALL BE REMOVED OR COVERED.

II. SPECIFIC TRAFFIC CONTROL REQUIREMENTS

- A. MAINTENANCE OF TRAFFIC
 - 1. FLAGGERS SHALL BE USED AT THE DIRECTION OF THE COUNTY INSPECTOR.
 - 2. FLAGGERS SHALL USE STOP/SLOW PADDLES TO DIRECT TRAFFIC.
 - 3. FLAGGERS SHALL BE MARYLAND STATE HIGHWAY ADMINISTRATION OR AATS APPROVED FLAGGERS.
 - 4. RADIO COMMUNICATION SHALL BE REQUIRED BETWEEN FLAGGERS AT THE DISCRETION OF THE COUNTY INSPECTOR OR UNDER THE FOLLOWING CONDITIONS:
 - a. IF THE FLAGGERS CANNOT SEE EACH OTHER.
 - b. IF THE LANE CLOSURE EXCEEDS 200 FEET.
 - 5. AT LEAST ONE 10 FOOT TRAVEL LANE SHALL BE AVAILABLE FOR TRAFFIC AT ALL TIMES.
 - 6. PROVISION SHALL BE MADE FOR SAFE MAINTENANCE OF PEDESTRIAN AND BICYCLE TRAFFIC, SUBJECT TO THE APPROVAL OF THE COUNTY'S DPS INSPECTOR.

B. INSTALLATION OF TRAFFIC CONTROL DEVICES

- 1. SIGNAGE, TRAFFIC DRUMS, AND ARROW PANELS SHALL BE PLACED IN ACCORDANCE WITH THE APPROPRIATE TYPICAL SPACING CHART AND AS LISTED ON THE TRAFFIC CONTROL PLANS.
- 2. ALL SIGNS AND TRAFFIC DRUMS SHALL BE FULLY REFLECTORIZED WITH HIGH INTENSITY, REFLECTIVE SHEETING AS PER THE MUTCD.
- 3. ALL WARNING SIGNS, UNLESS OTHERWISE SPECIFIED, SHALL BE A MINIMUM OF 48 " X 48", BLACK SYMBOL OR LEGEND ON ORANGE BACKGROUND AND DIAMOND SHAPED. PLACEMENT OF ALL SIGNS SHALL NOT INTERFERE WITH TRAVELED WAYS OR SIGHT DISTANCES OF ANY ROADWAY, STREET OR DRIVEWAY AS PER AASHTO POLICY ON GEOMETRIC DESIGN OF HIGHWAYS AND STREETS, LATEST EDITION. ALL WARNING SIGNS NOT APPLICABLE TO THE ACTUAL SITUATION SHALL BE REMOVED OR COVERED DURING NON-APPLICABLE PERIODS.
- 4. VARIABLE MESSAGE SIGNS (IF REQUIRED) SHALL BE PROVIDED TWO WEEKS BEFORE AFTER AND DURING CONSTRUCTION. LOCATION AND MESSAGE TO BE DETERMINED BY ENGINEER.
- 5. DURING NIGHTTIME OPERATIONS, REFLECTORIZED TRAFFIC DRUMS SHOULD BE USED. HOWEVER, FOR EMERGENCY WORK ACTIVITIES, WHERE TRAFFIC DRUMS ARE NOT READILY AVAILABLE, REFLECTORIZED TRAFFIC CONES THAT ARE A MINIMUM OF TWENTY EIGHT (28) INCHES IN HEIGHT AND HAVING SIX (6) INCH AND FOUR (4) INCH REFLECTIVE COLLARS WITHIN THE TOP SIXTEEN (16) INCHES OF THE CONE MAY BE USED. ALL WORK AREAS LEFT UNATTENDED AT NIGHT SHALL BE DELINEATED WITH REFLECTORIZED TRAFFIC DRUMS.
- 6. CONTRACTOR SHALL EXCAVATE ONLY AS MUCH AS IS TO BE WORKED IN A DAY. IN CASE ANY EXCAVATED AREA IS LEFT OVERNIGHT, TEMPORARY CONCRETE BARRIERS SHALL BE PLACED SURROUNDING THAT AREA.
- 7. ALL PORTABLE SIGNS SHALL BE MOUNTED A MINIMUM OF ONE (1) FOOT ABOVE THE LEVEL OF THE ROADWAY, WITH HIGHER MOUNTING HEIGHTS DESIRABLE.
- 8. WHEN PAVEMENT MARKINGS HAVE BEEN OBLITERATED BY THE WORK ACTIVITY, THE PERMITTEE SHALL INSTALL ANY CRITICAL INTERIM PAVEMENT MARKINGS PRIOR TO THE END OF THE WORK DAY AS SPECIFIED BY THE COUNTY'S DPS INSPECTOR AND/OR THE DIVISION OF TRAFFIC ENGINEERING AND OPERATIONS.
 - a. ON ROAD SECTIONS THAT ARE NOT SCHEDULED TO BE OVERLAID, ALL TEMPORARY PAVEMENT MARKINGS SHALL BE (REMOVABLE) DETOUR GRADE MARKING TAPE. ANY CONFLICTING MARKINGS WHICH NEED TO BE TEMPORARILY REMOVED ARE TO BE MASKED USING "3M REMOVABLE BLACK LANE MASK" OR AN APPROVED EQUAL.

III. CONTACT INFORMATION

- A. CONTACT THE MCDOT TRANSPORTATION MANAGEMENT CENTER 240-777-2100 BETWEEN 5:00 AM AND 11:00 PM TO INFORM THEM OF TEMPORARY LANE CLOSURES IN THE VICINITY OF ANY TRAFFIC SIGNALS.
- B. CONTACT TRAFFIC ENGINEERING DESIGN AND OPERATIONS SECTION AT 240-777-2190 (A MINIMUM OF ONE WEEK PRIOR) TO COORDINATE ANY MINOR TRAFFIC SIGNAL RELOCATIONS TO FACILITATE THIS WORK ACTIVITY. MAJOR SIGNAL RELOCATIONS SHALL BE COORDINATED A MINIMUM OF THIRTY (30) DAYS IN ADVANCE OF THE PROJECT. THE PERMITTEE SHALL CONTACT THE MONTGOMERY COUNTY TECHNICAL CENTER AT 301-279-1291 A MINIMUM OF 48 HOURS PRIOR TO BEGINNING WORK TO HAVE TRAFFIC SIGNAL EQUIPMENT MARKED.
- C. CONTACT TRAFFIC ENGINEERING STUDIED SECTION AT 240-777-2190 AT LEAST TEN (10) WORKING DAYS IN ADVANCE OF THE FINAL PAVING OPERATION TO SCHEDULE THE INSTALLATION OF PERMANENT PAVEMENT MARKINGS AND SIGNS.
- D. CONTACT MS. STELLA O. IGBINEDION AT 240-777-2190 TO REQUEST ANY FIELD ASSISTANCE BY THE MCDOT DIVISION OF TRAFFIC ENGINEERING AND OPERATION.



SEQUENCE OF CONSTRUCTION

- 1. GENERAL
 - DURING CONSTRUCTION, TRAFFIC SHALL BE MAINTAINED ON THE EXISTING ROADWAYS. THE CONSTRUCTION EFFORT SHALL BE DIRECTED TO COMPLETING THE SHARED USE PATH OF THE NORWOOD ROAD AS DESCRIBED BELOW. SIDEWALK RAMPS, INSTALLATION OF TRAFFIC SIGNAL AT THE INTERSECTION OF NORWOOD ROAD AND MD 108, INSTALLATION OF LIGHT POLES ALONG SHARED USE PATH, RELOCATION OF GAS LINE, AND INSTALLATION OF STORM DRAIN SYSTEM.
 - PRIOR TO THE COMMENCEMENT OF WORK, THE CONTRACTOR SHALL NOTIFY THE PROPERTY OWNERS AS TO THE DURATION OF THE PROPOSED WORK AS SPECIFIED IN THE SPECIAL PROVISIONS. THE CONTRACTOR CAN ALSO INFORM THE OWNER OF ANY EQUIPMENT THAT NEEDS TO BE RELOCATED.
- 2. SEQUENCE OF CONSTRUCTION
 - A. INSTALL ALL TEMPORARY SIGNING AND MARKING REQUIRED FOR THE INITIAL CONSTRUCTION WORK TO BE PERFORMED.
 - B. PRIOR TO COMMENCING ANY WORK AT ANY GIVEN LOCATION, THE INSTALLATION OF ALL NECESSARY SEDIMENT CONTROL FACILITIES REQUIRED DURING CONSTRUCTION MUST BE COMPLETED AND HAVE THE APPROVAL OF THE EROSION AND SEDIMENT CONTROL INSPECTOR.
 - C. MAKING USE OF FLAGGING OPERATION AS PER MCDOT TCP-102.02, AND TCP-105.06, MAINTAIN ONE LANE TWO WAY TRAFFIC ON NORWOOD ROAD DURING WORKING HOURS.
 - D. CONSTRUCT NORWOOD SHARED USE PATH, RESIDENTIAL DRIVEWAYS, CURB AND GUTTER, SIDEWALK RAMPS AND STORM DRAIN SYSTEM AS SHOWN ON THE TCP PLANS. ALL CONSTRUCTION ACTIVITY THAT IMPACTS RESIDENTIAL PROPERTY MUST BE COORDINATED WITH THE PROPERTY OWNERS PRIOR TO THE START OF WORK, AND DONE IN ACCORDANCE WITH DIRECTIVES INCLUDED ELSEWHERE IN THE CONTRACT DOCUMENTS.
 - E. COVER TEMPORARY SIGNS BEING USED DURING WORKING HOURS.
 - F. INSTALL TEMPORARY CHANNELIZATION DEVICES AND TEMPORARY TRAFFIC SIGNS AS SHOWN ON THE TCP PLANS AS PER MCDOT TCP- 102.01 OR AS DIRECTED BY THE ENGINEER FOR MAINTENANCE OF TRAFFIC DURING NON-WORKING HOURS.
 - G. RESTORE FLAGGING OPERATION AND APPLICABLE TEMPORARY SIGNS DURING WORKING HOURS.
 - H. AT THE COMPLETION OF WORK, REMOVE ALL TEMPORARY TRAFFIC CONTROL DEVICES.

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						MONTGOMERY COUNTY DEPARTMENT OF TRANSPORTATION ROCKVILLE, MARYLAND	MONTGOMERY COUNTY DEPARTMENT OF TRANSPORTATION DIVISION OF TRANSPORTATION ENGINEERING NORWOOD ROAD SHARED USE PATH TRAFFIC CONTROL PLAN
						RECOMMENDED FOR APPROVAL	
						Chief, Transportation Planning and Design Section _____ Date _____ APPROVED	
						Chief, Division of Transportation Engineering _____ Date _____	
NO.	REVISION	DATE	BY	DESIGNED BY <u>RA</u>	DRAWN BY <u>NM</u>	CHECKED BY <u>MWM</u>	SCALE <u>NTS</u> DATE <u>NOVEMBER, 2023</u>
							SHEET NO. <u>8</u> OF <u>20</u>



INSTALL 12 INCH BLACK OUT TAPE LINES OVER EXISTING PAVEMENT MARKINGS

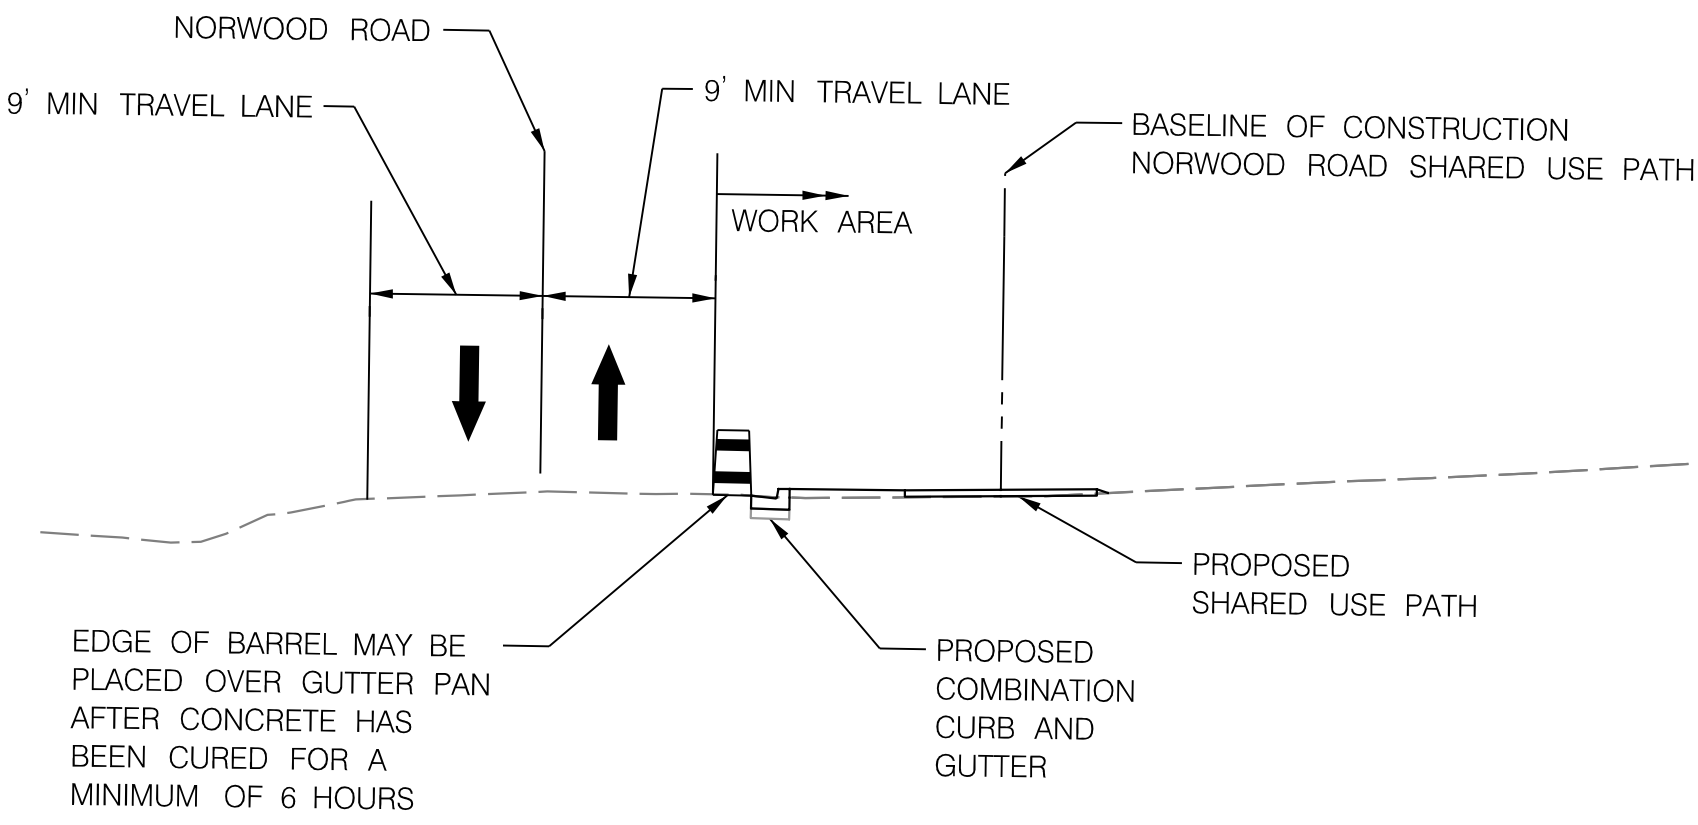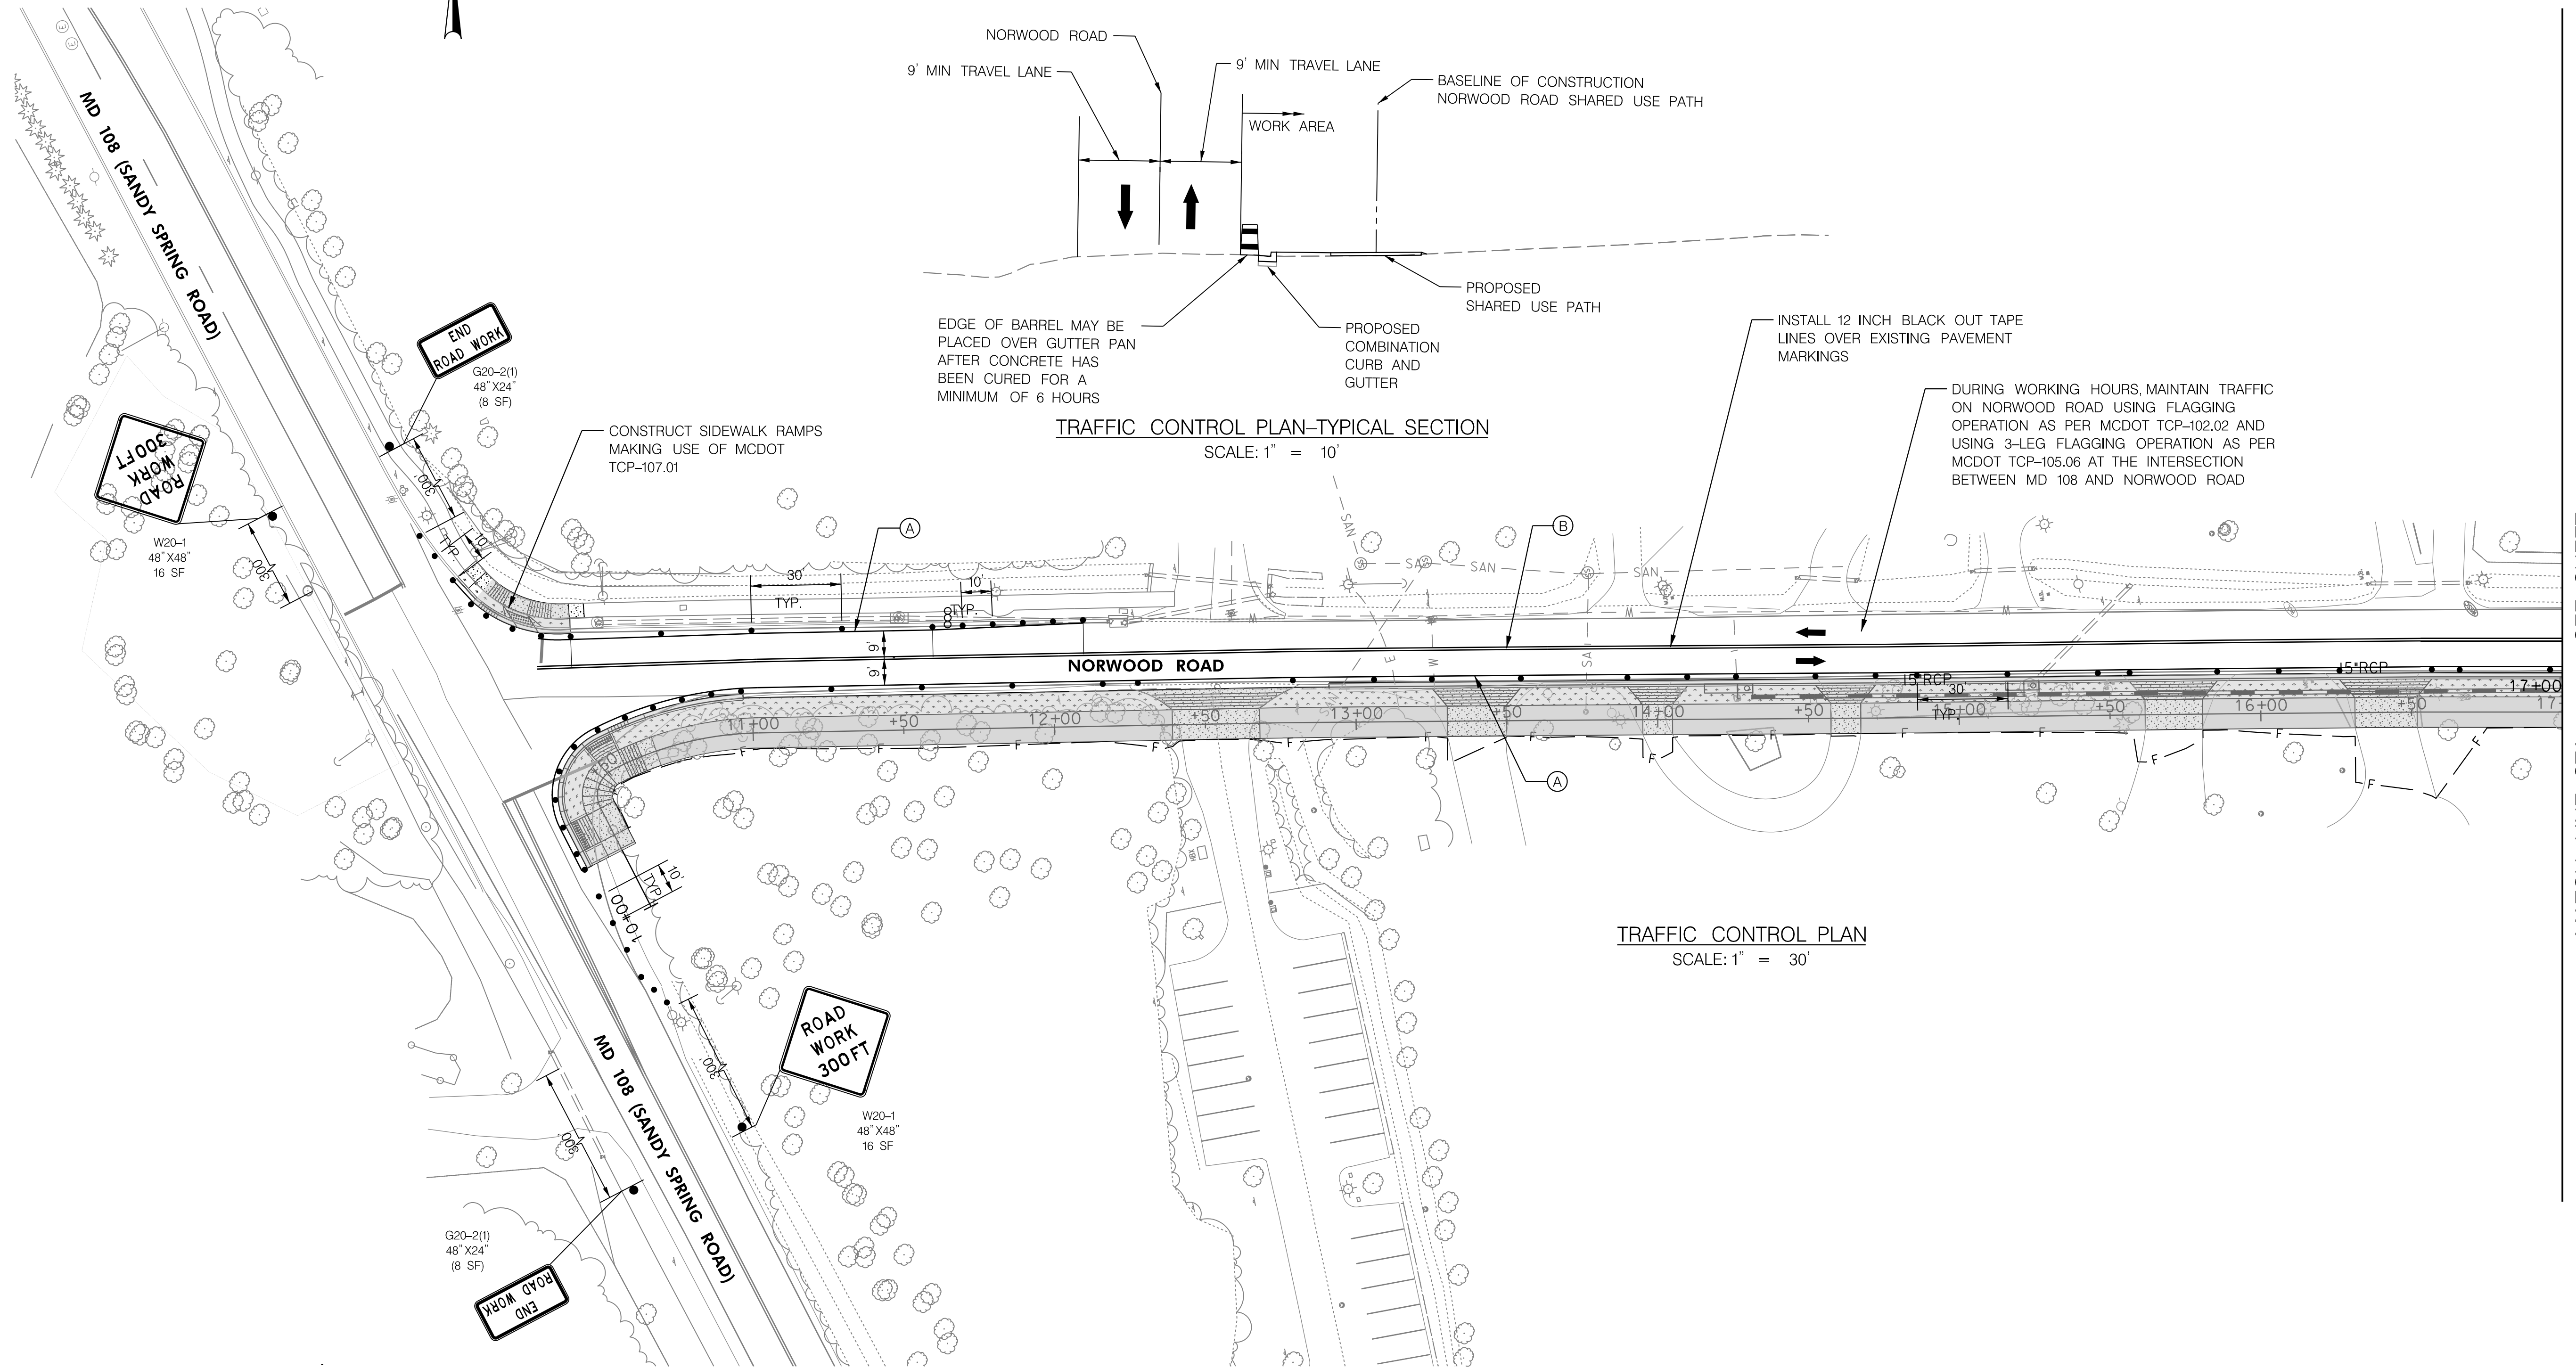DURING WORKING HOURS, MAINTAIN TRAFFIC ON NORWOOD ROAD USING FLAGGING OPERATION AS PER MCDOT TCP-102.02 AND USING 3-LEG FLAGGING OPERATION AS PER MCDOT TCP-105.06 AT THE INTERSECTION BETWEEN MD 108 AND NORWOOD ROAD

MATCH LINE STA. 17+00, SEE SHEET 10

- CURRENT WORKZONE
- TRAFFIC FLOW ARROW
- DRUMS
- TEMPORARY TRAFFIC SIGN SUPPORT
- ARROW PANEL
- TEMPORARY TRAFFIC SIGN
- (A) 5 INCH WHITE REMOVABLE PAVEMENT LINE MARKINGS
- (B) 5 INCH DOUBLE YELLOW REMOVABLE PAVEMENT LINE MARKINGS




					MONTGOMERY COUNTY DEPARTMENT OF TRANSPORTATION ROCKVILLE, MARYLAND	MONTGOMERY COUNTY DEPARTMENT OF TRANSPORTATION DIVISION OF TRANSPORTATION ENGINEERING NORWOOD ROAD SHARED USE PATH
					RECOMMENDED FOR APPROVAL	
					Chief, Transportation Planning and Design Section	Date
					APPROVED	
					Chief, Division of Transportation Engineering	Date
NO.	REVISION	DATE	BY	DESIGNED BY <u>RA</u>	DRAWN BY <u>NM</u>	CHECKED BY <u>MML</u>
						TRAFFIC CONTROL PLAN—NON WORKING HOURS SCALE <u>1"=30'</u> DATE <u>NOVEMBER, 2023</u>
						SHEET NO. <u>9</u> OF <u>20</u>

PLOTTER: 11x17x24
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MATCH LINE STA 17+00, SEE SHEET 9



DURING WORKING HOURS, MAINTAIN TRAFFIC ON NORWOOD ROAD USING FLAGGING OPERATION AS PER MCDOT TCP-102.02

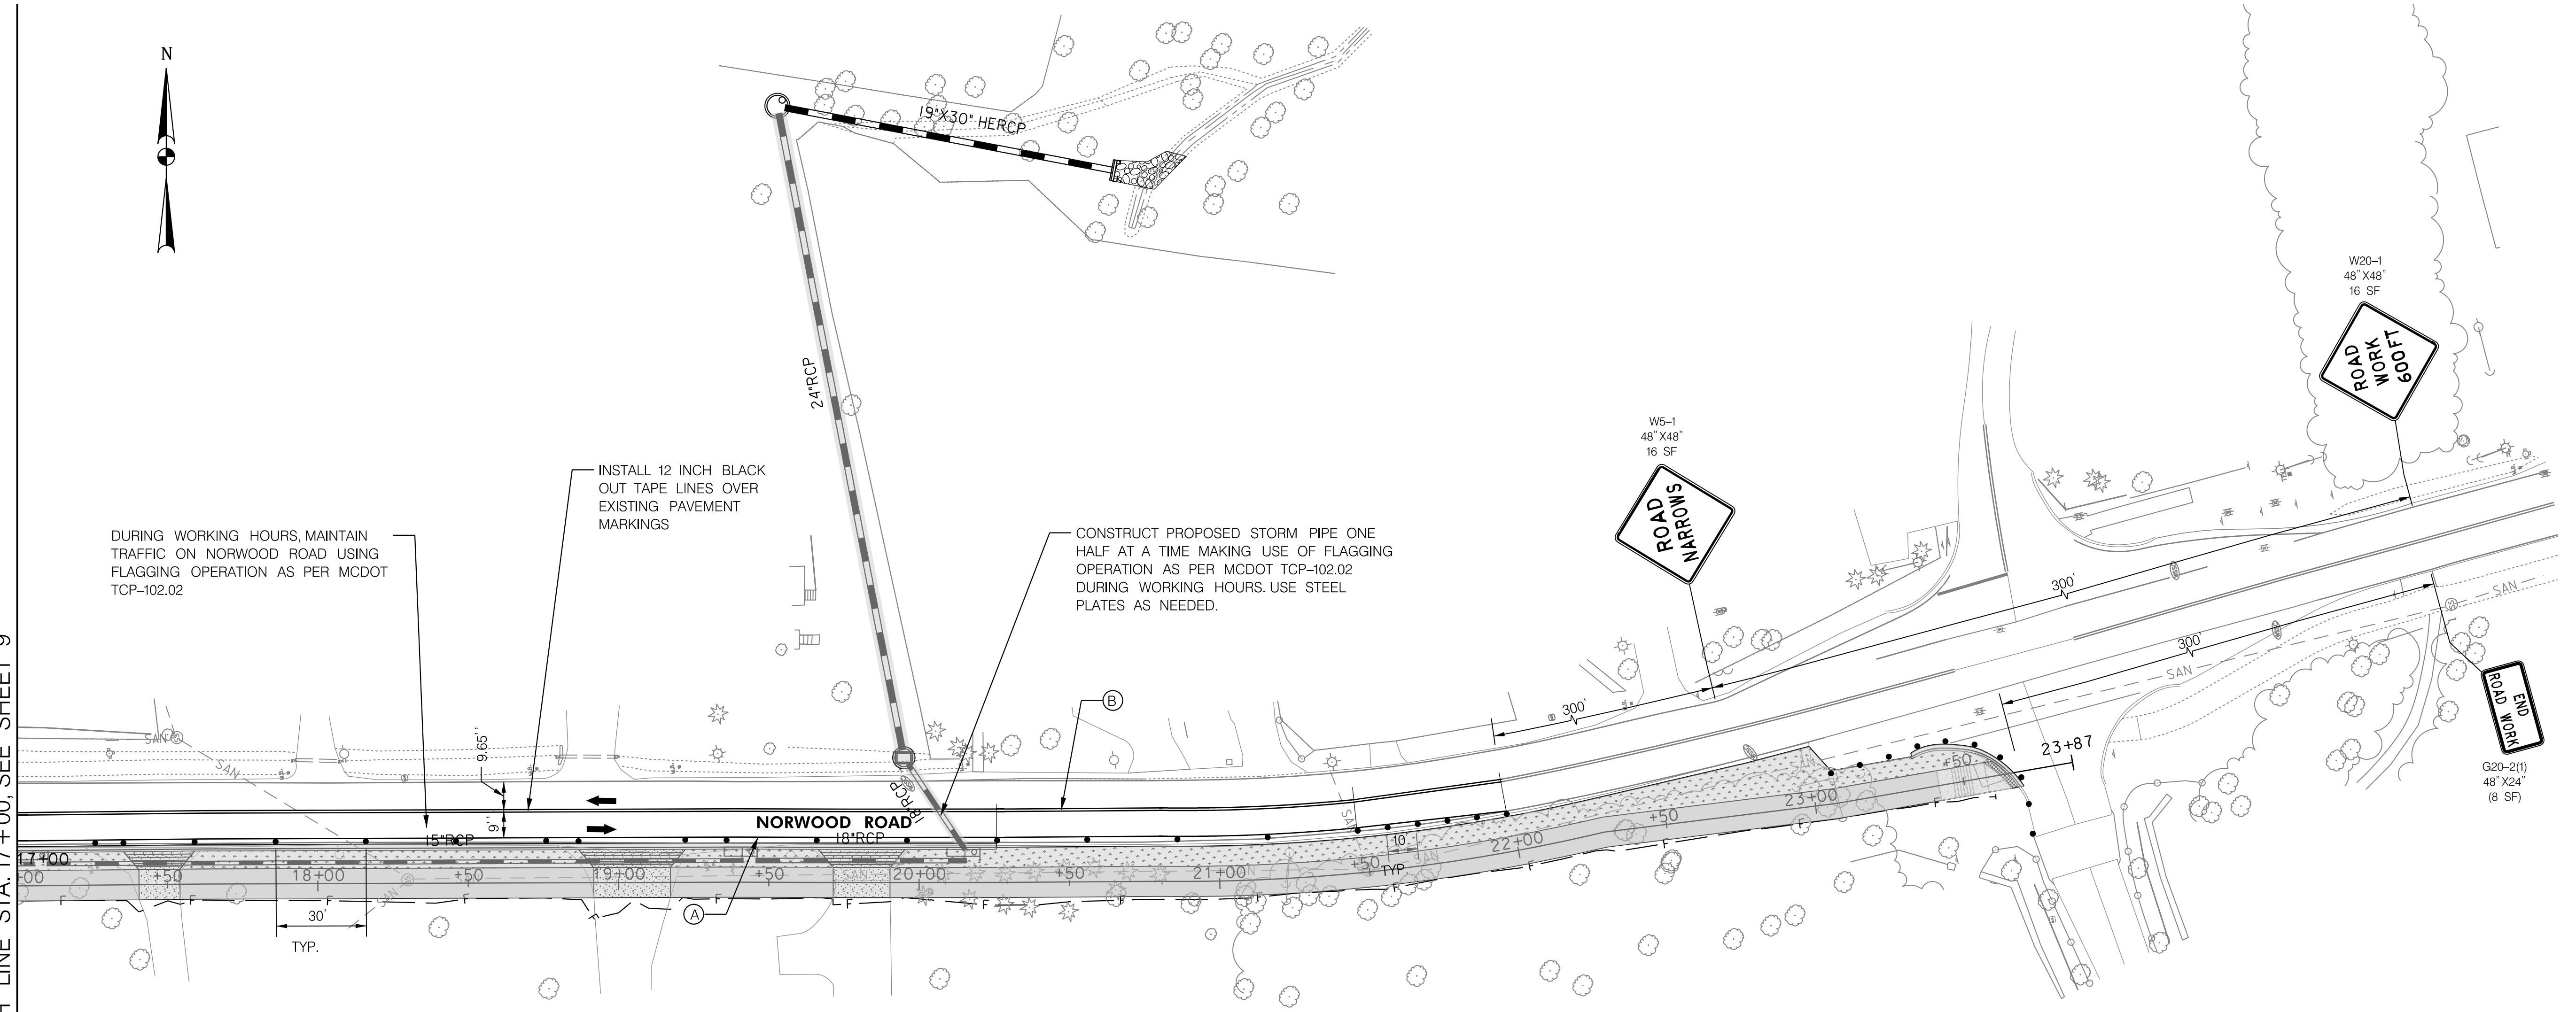INSTALL 12 INCH BLACK OUT TAPE LINES OVER EXISTING PAVEMENT MARKINGS

CONSTRUCT PROPOSED STORM PIPE ONE HALF AT A TIME MAKING USE OF FLAGGING OPERATION AS PER MCDOT TCP-102.02 DURING WORKING HOURS. USE STEEL PLATES AS NEEDED.

LEGEND

- CURRENT WORKZONE
- TRAFFIC FLOW ARROW
- DRUMS
- TEMPORARY TRAFFIC SIGN SUPPORT
- ARROW PANEL
- A 5 INCH WHITE REMOVABLE PAVEMENT LINE MARKINGS
- B 5 INCH DOUBLE YELLOW REMOVABLE PAVEMENT LINE MARKINGS
- ROAD WORK 300 FT TEMPORARY TRAFFIC SIGN



PLOTTER: 11x17x24
FILE: \\server01\mercado_data\1\Projects\1008\1008.dwg Stanley, Spring, Blenny\05_Roadway\CADD\JMT-Prtg_Norwood.dwg

NO.	REVISION	DATE	BY

MONTGOMERY COUNTY
DEPARTMENT OF TRANSPORTATION
ROCKVILLE, MARYLAND

RECOMMENDED FOR APPROVAL

Chief, Transportation Planning and Design Section _____ Date _____

APPROVED

Chief, Division of Transportation Engineering _____ Date _____

DESIGNED BY RA DRAWN BY NM CHECKED BY MML

MONTGOMERY COUNTY
DEPARTMENT OF TRANSPORTATION
DIVISION OF TRANSPORTATION ENGINEERING

NORWOOD ROAD SHARED USE PATH

TRAFFIC CONTROL PLAN—NON WORKING HOURS

SCALE 1"=30' DATE NOVEMBER, 2023

SHEET NO. 10 OF 20

CONTRACTOR CANNOT BEGIN CONSTRUCTION UNTIL CLEAR LEGAL ACCESS HAS BEEN GRANTED TO ENTIRE LOD. TEMPORARY CONSTRUCTION EASEMENTS MUST BE SUBMITTED TO SEDIMENT CONTROL INSPECTOR PRIOR TO PRECONSTRUCTION MEETING.

EROSION AND SEDIMENT CONTROL SEQUENCE OF CONSTRUCTION:

1. PRIOR TO CLEARING TREES, INSTALLING SEDIMENT CONTROL MEASURES, OR GRADING, A PRECONSTRUCTION MEETING MUST BE CONDUCTED ON-SITE WITH THE MONTGOMERY COUNTY DEPARTMENT OF PERMITTING SERVICES (MCDPS) SEDIMENT CONTROL INSPECTOR (240) 777-0311 (48 HOURS NOTICE) AND THE MNCPPC, PLANNING DEPARTMENT, PLANS ENFORCEMENT INSPECTOR (301) 495-4550 (48 HOURS NOTICE), THE OWNERS REPRESENTATIVE, AND THE SITE ENGINEER. IN ORDER FOR THE MEETING TO OCCUR, THE APPLICANT MUST PROVIDE ONE PAPER SET OF APPROVED SEDIMENT CONTROL PLANS TO MCDPS SEDIMENT CONTROL INSPECTOR AT THE PRECONSTRUCTION MEETING. IF NO PLANS ARE PROVIDED, THE MEETING SHALL NOT OCCUR AND WILL NEED TO BE RESCHEDULED PRIOR TO COMMENCING ANY WORK.
2. THE LIMITS OF DISTURBANCE MUST BE FIELD MARKED PRIOR TO CLEARING OF TREES, INSTALLATION OF SEDIMENT CONTROL MEASURES, CONSTRUCTION, OR OTHER LAND DISTURBING ACTIVITIES.
3. THE PERMITTEE MUST OBTAIN WRITTEN APPROVAL FROM THE MNCPPC INSPECTOR, CERTIFYING THAT THE LIMITS OF DISTURBANCE AND TREE PROTECTION MEASURES ARE CORRECTLY MARKED AND INSTALLED PRIOR TO COMMENCING ANY CLEARING.
4. CLEAR AND GRADE FOR INSTALLATION OF SEDIMENT CONTROL DEVICES.
5. INSTALL ALL TREE PROTECTION FENCE, FILTER LOG, AND STABILIZED CONSTRUCTION ENTRANCES AS SHOWN ON THE PLANS. ONCE THESE SEDIMENT CONTROL DEVICES ARE INSTALLED, THE PERMITTEE MUST OBTAIN WRITTEN APPROVAL FROM THE MCDPS INSPECTOR BEFORE PROCEEDING WITH ANY ADDITIONAL CLEARING, GRUBBING OR GRADING.
6. INSTALL CLASS IRIPRAP AT OUTFALL OF HW-1, I-6, MH-1, HW-1, AND ALL STORM DRAIN PIPES BETWEEN I-6 TO HW-1.
7. INSTALL INLET PROTECTION SIP 2.1.
8. INSTALL SILT FENCE SF 2.4, SF 2.5, SF 2.6, AND SF 2.7. CONSTRUCT SHARED USE PATH BETWEEN 20+26 TO 23+67.
9. INSTALL I-3, I-4, AND I-5 ALONG WITH ALL STORM DRAIN PIPES, CURB AND GUTTER, GRASS BUFFER, AND DRIVEWAY APRONS BETWEEN I-3 TO I-5. INSTALL STORM DRAIN BETWEEN I-5 AND I-6.
10. INSTALL SILT FENCE SF 2.1, SF 2.2, AND SF 2.3. INSTALL INLET PROTECTION CIP 2.1, CIP 2.2, AND CIP 2.3.
11. INSTALL SHARED USE PATH BETWEEN I-3 AND I-5 (STA. 17+10 TO 20+26).
12. INSTALL I-1 AND I-2 ALONG WITH ALL STORM DRAIN PIPES, CURB AND GUTTER, GRASS BUFFER, AND DRIVEWAY APRONS BETWEEN I-1 TO I-3. INSTALL STORM DRAIN BETWEEN I-5 AND I-6. FILL EXISTING CMP STORM DRAIN CROSSING NORWOOD ROAD AT I-2 WITH FLOWABLE FILL CONCRETE, EXCAVATE AND REMOVE 5' FROM DOWNSTREAM END OF EXISTING CMP, AND BURY CMP OUTFALL WITH SOIL TO MATCH EXISTING EMBANKMENT SLOPE ALONG NORWOOD ROAD.
13. INSTALL SILT FENCE SF 1.4, SF 1.5, SF 1.6, AND SF 1.7. INSTALL INLET PROTECTION CIP 1.1 AND CIP 1.2.
14. INSTALL SHARED USE PATH BETWEEN I-1 AND I-3 (STA. 14+25 TO 17+10).
15. INSTALL SILT FENCE SF 1.1, SF 1.2, AND SF 1.3.
16. INSTALL ALL CURB AND GUTTER, GRASS BUFFER, AND DRIVEWAY APRONS FROM 12+91 TO 14+25.
17. CONSTRUCT REMAINING SHARED USE PATH FROM 10+21 TO 14+25.
18. INSTALL NEW TRAFFIC SIGNAL POLES AT NORWOOD ROAD AND OLNEY SANDY SPRING ROAD AND COMPLETE CONSTRUCTION OF INTERSECTION.
19. STABILIZE ALL REMAINING DISTURBED AREAS.
20. REMOVE SEDIMENT CONTROL DEVICES AFTER WRITTEN APPROVAL OF ENGINEER AND MCDPS INSPECTOR.

PLOTTER: 11x17x24in
FILE: P:\Projects\1908\1908.04_Sandy_Spring_Bikeway\08_Water_Resources\ESCD\ES-N001_Norwood.dgn



SC0005

MONTGOMERY COUNTY DEPARTMENT OF TRANSPORTATION ROCKVILLE, MARYLAND				MONTGOMERY COUNTY DEPARTMENT OF TRANSPORTATION DIVISION OF TRANSPORTATION ENGINEERING NORWOOD ROAD SHARED USE PATH EROSION AND SEDIMENT SEQUENCE OF CONSTRUCTION SCALE <u>1"=30'</u> DATE <u>NOVEMBER, 2023</u>		
RECOMMENDED FOR APPROVAL						
Chief, Transportation Planning and Design Section _____ Date _____ APPROVED						
Chief, Division of Transportation Engineering _____ Date _____						
NO.	REVISION	DATE	BY	DESIGNED BY <u>RA</u>	DRAWN BY <u>NM</u>	CHECKED BY <u>MWM</u>
				SHEET NO. <u>14</u> OF <u>20</u>		

INLET PROTECTION (IP)			
ID NO.	STATION	QUANTITY	DRAINAGE AREA (AC)
CIP 1.1	STA. 14+24, LT	1 EA	0.7
CIP 1.2	STA. 15+19, LT	1 EA	0.47



STABILIZED CONSTRUCTION ENTRANCE (SCE)		
ID NO.	QUANTITY	STATION
SCE 1.1	1 EA	STA. 10+53
SCE 1.2	1 EA	STA. 14+98

SILT FENCE		
ID NO.	QUANTITY	STATION
SF 1.1	47 LF	STA. 12+78, LT
SF 1.2	30 LF	STA. 13+59, LT
SF 1.3	5 LF	STA. 14+10, LT
SF 1.4	20 LF	STA. 14+32, LT
SF 1.5	42 LF	STA. 14+73, LT
SF 1.6	34 LF	STA. 15+88, LT
SF 1.7	42 LF	STA. 16+57, LT

12-INCH FILTER LOG		
ID NO.	QUANTITY	STATION
FL 1.1	35 LF	STA. 10+20, RT
FL 1.2	228 LF	STA. 10+50, LT

TREE PROTECTION FENCE (TPF)		
ID NO.	QUANTITY	STATION
TPF 1.1	207 LF	STA. 10+20, RT

- LEGEND**
- LOD — LIMITS OF DISTURBANCE
 - SF — SILT FENCE
 - SCE — STABILIZED CONSTRUCTION ENTRANCE
 - SIP — STANDARD INLET PROTECTION
 - CIP — CURB INLET PROTECTION
 - ⊗ — TREE TO BE REMOVED
 - TPF — TREE PROTECTION FENCE
 - FL-12 — 12" FILTER LOG

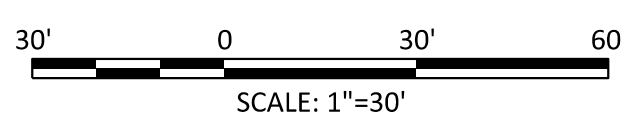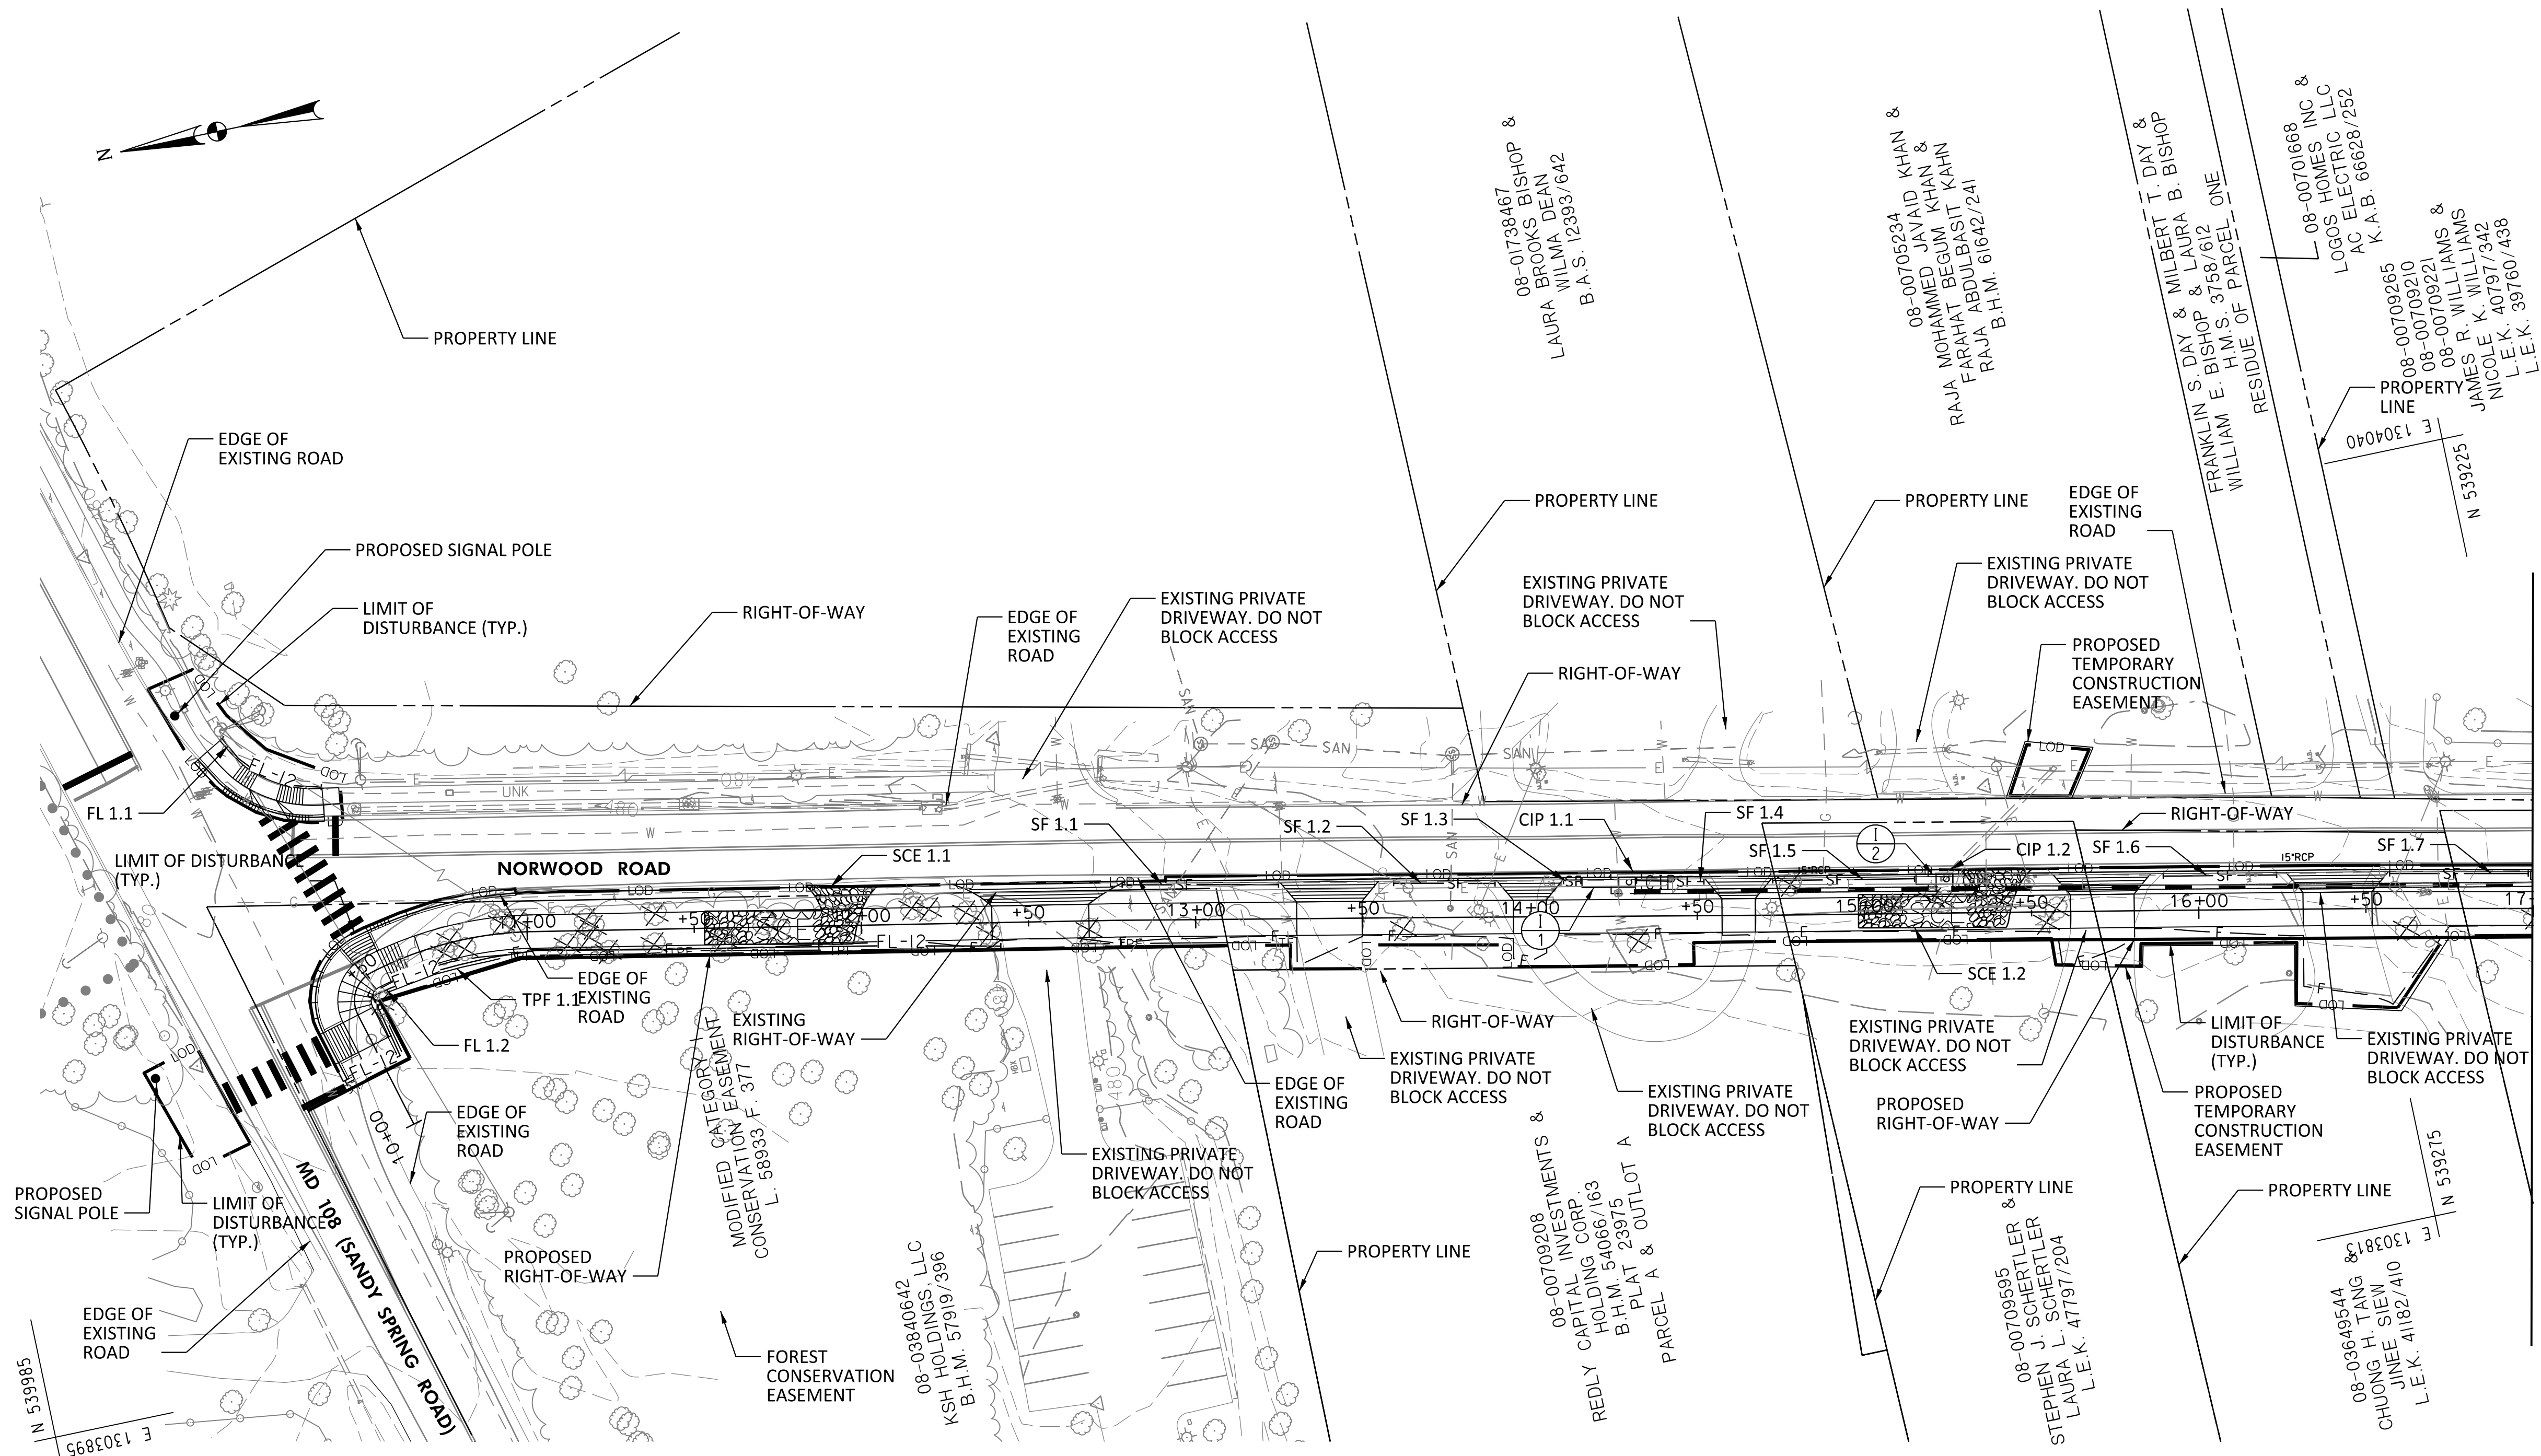


MATCH LINE STA. 17 + 00, SEE SHEET 14



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MONTGOMERY COUNTY DEPARTMENT OF TRANSPORTATION ROCKVILLE, MARYLAND				MONTGOMERY COUNTY DEPARTMENT OF TRANSPORTATION DIVISION OF TRANSPORTATION ENGINEERING					
				RECOMMENDED FOR APPROVAL Chief, Transportation Planning and Design Section _____ Date _____ APPROVED Chief, Division of Transportation Engineering _____ Date _____				NORWOOD ROAD SHARED USE PATH EROSION AND SEDIMENT CONTROL PLAN SCALE 1"=30' DATE NOVEMBER, 2023	
NO.	REVISION	DATE	BY	DESIGNED BY	DRAWN BY	CHECKED BY	M.M.M.	SHEET NO. 15 OF 20	



MATCH LINE STA. 17+00, SEE SHEET 13

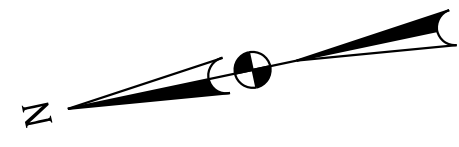

INLET PROTECTION (IP)			
ID NO.	STATION	QUANTITY	DRAINAGE AREA (AC)
CIP 2.1	STA. 17+04, LT	1 EA	0.45
CIP 2.2	STA. 19+40, LT	1 EA	0.67
CIP 2.3	STA. 20+15, LT	1 EA	0.75
SIP 2.1	STA. 19+90, LT	1 EA	0.70

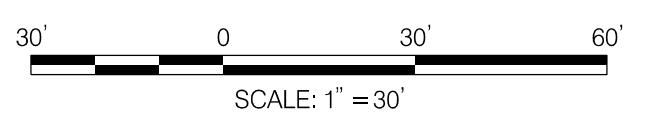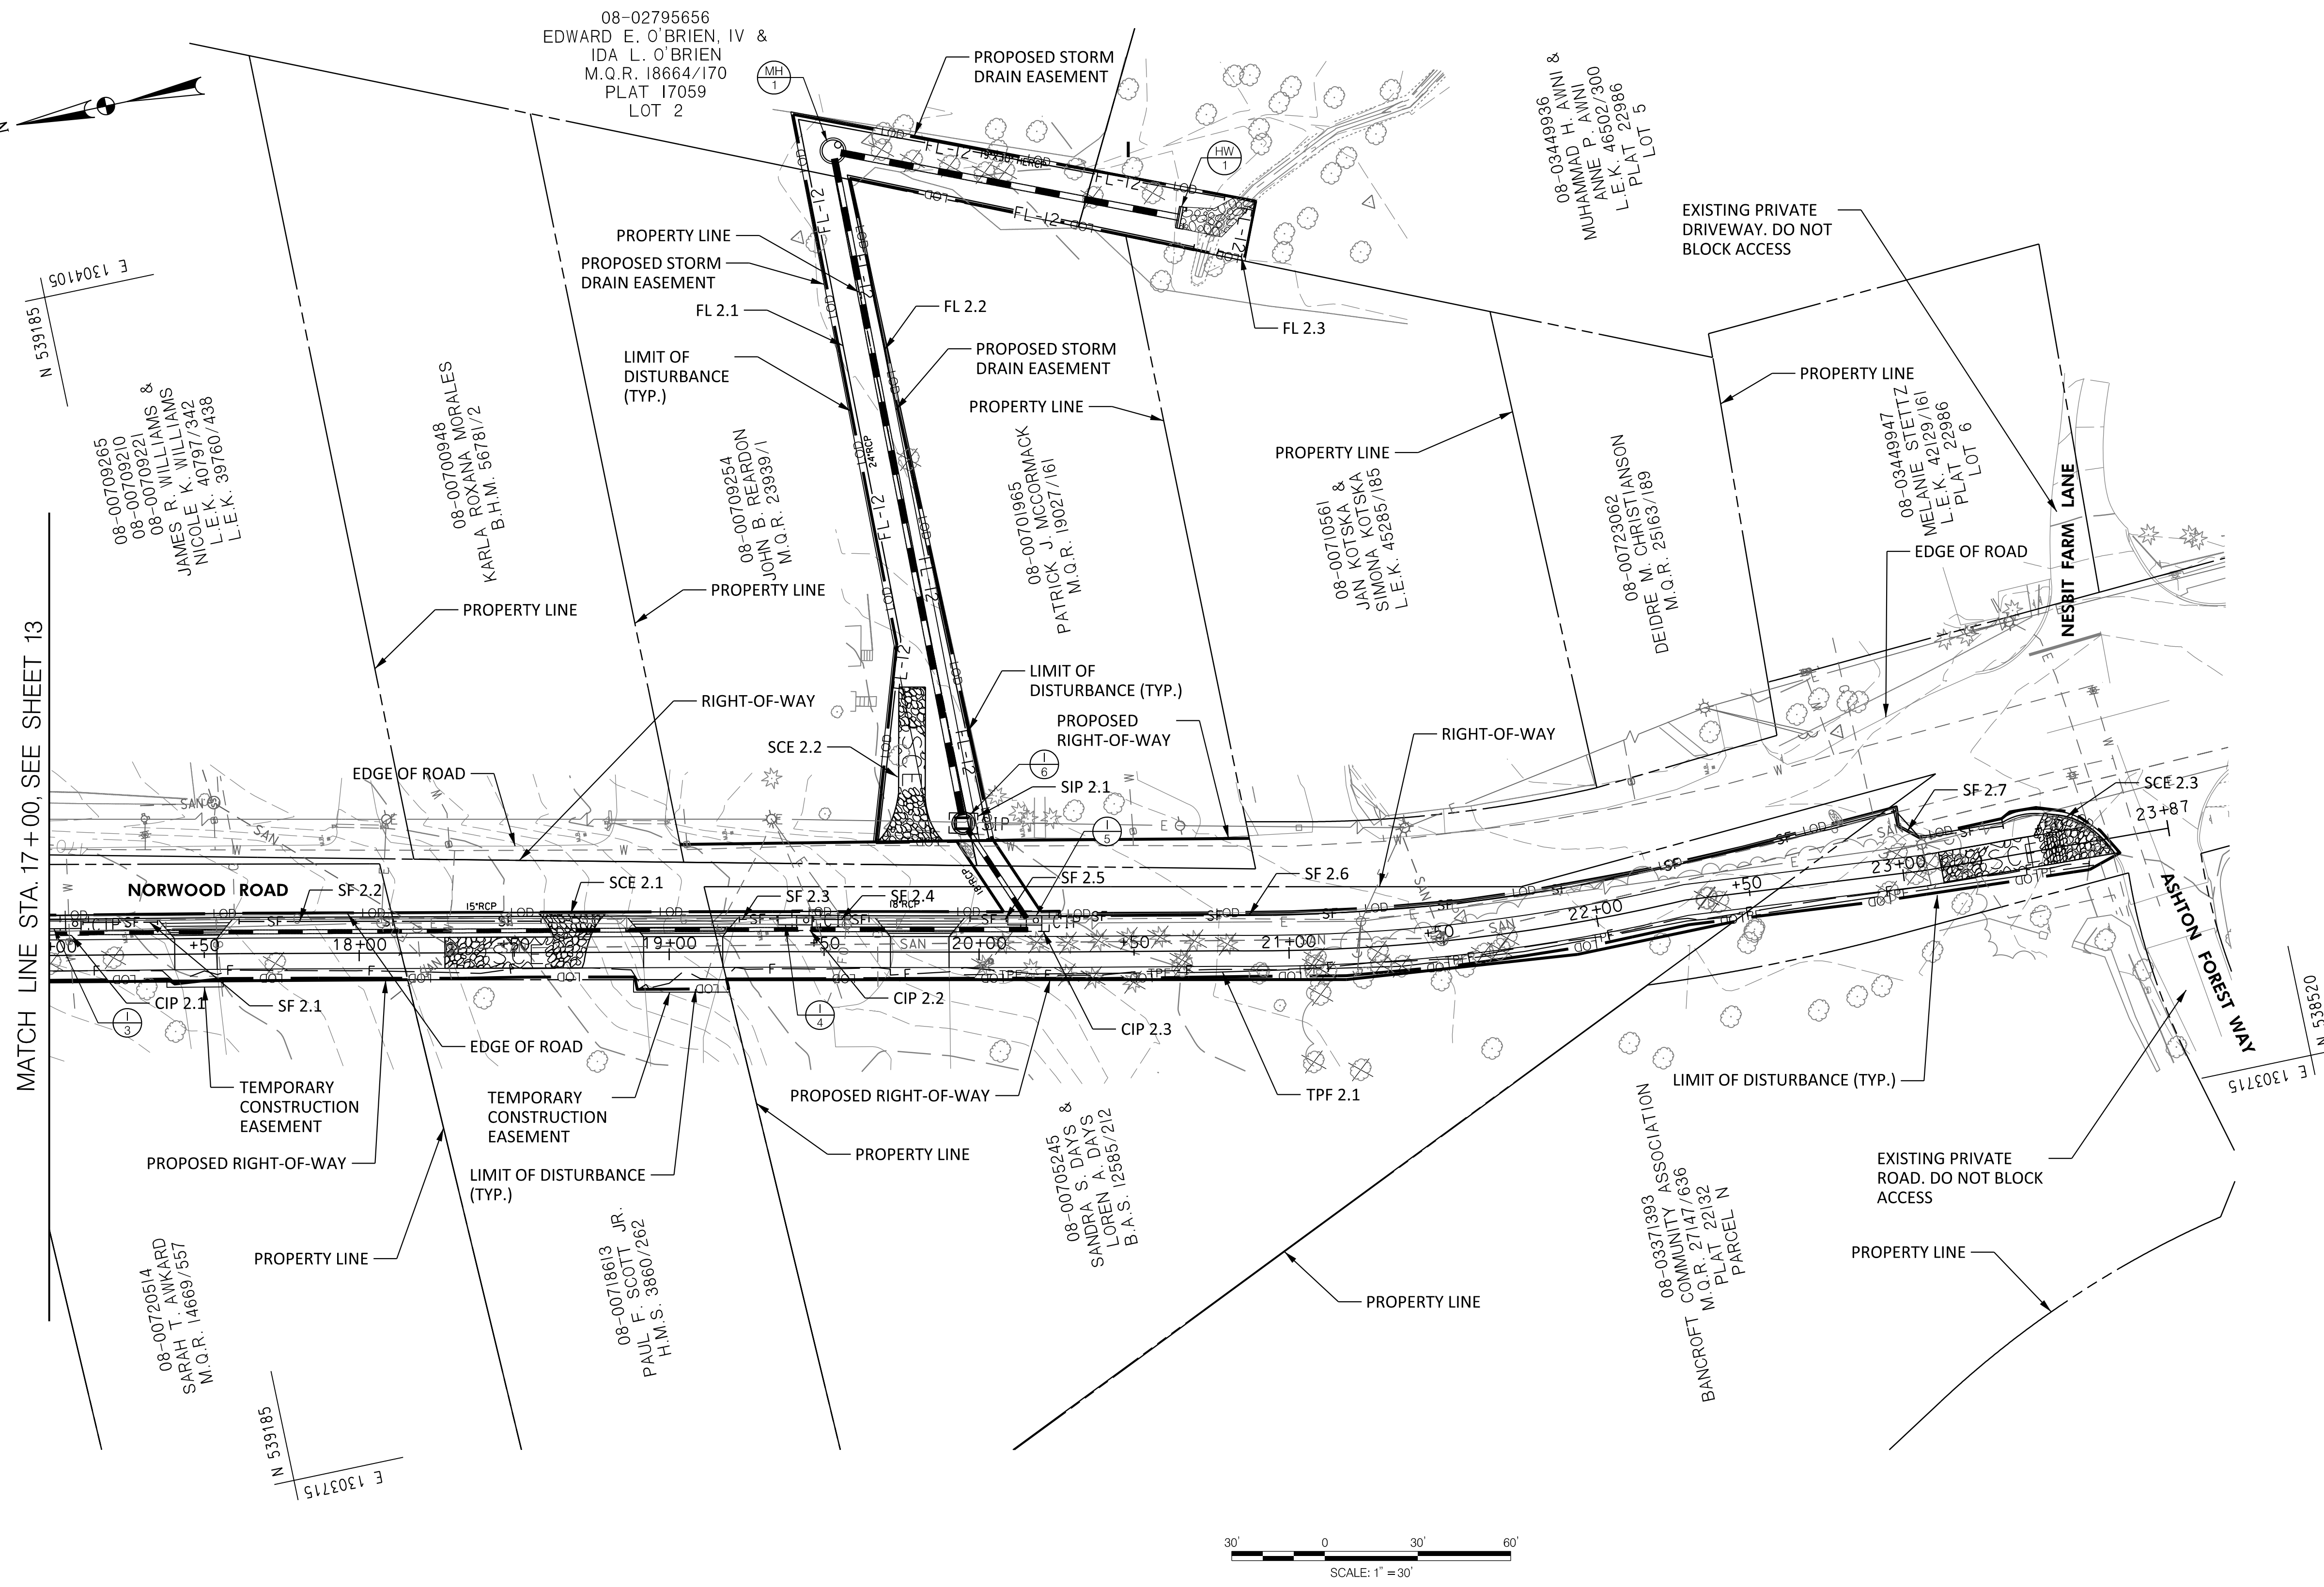STABILIZED CONSTRUCTION ENTRANCE (SCE)		
ID NO.	QUANTITY	STATION
SCE 2.1	1 EA	STA. 18+28
SCE 2.2	1 EA	STA. 19+70, LT
SCE 2.3	1 EA	STA. 23+12

SILT FENCE		
ID NO.	QUANTITY	STATION
SF 2.1	24 LF	STA. 17+11, LT
SF 2.2	98 LF	STA. 17+62, LT
SF 2.3	12 LF	STA. 19+23, LT
SF 2.4	18 LF	STA. 19+47, LT
SF 2.5	12 LF	STA. 19+97, LT
SF 2.6	270 LF	STA. 20+26, LT
SF 2.7	41 LF	STA. 22+98, LT

12-INCH FILTER LOG		
ID NO.	QUANTITY	STATION
FL 2.1	376 LF	STA. 19+88, LT
FL 2.2	333 LF	STA. 20+03, LT
FL 2.3	24 LF	STA. 20+77, LT

TREE PROTECTION FENCE (TPF)		
ID NO.	QUANTITY	STATION
TPF 2.1	367 LF	STA. 19+95, RT

- LEGEND**
- LIMITS OF DISTURBANCE
 - SILT FENCE
 - STABILIZED CONSTRUCTION ENTRANCE
 - STANDARD INLET PROTECTION
 - CURB INLET PROTECTION
 - TREE TO BE REMOVED
 - TREE PROTECTION FENCE
 - 12" FILTER LOG

SC0007



MONTGOMERY COUNTY
DEPARTMENT OF TRANSPORTATION
ROCKVILLE, MARYLAND

RECOMMENDED FOR APPROVAL

Chief, Transportation Planning and Design Section _____ Date _____

APPROVED

Chief, Division of Transportation Engineering _____ Date _____

MONTGOMERY COUNTY
DEPARTMENT OF TRANSPORTATION
DIVISION OF TRANSPORTATION ENGINEERING

NORWOOD ROAD SHARED USE PATH

EROSION AND SEDIMENT CONTROL PLAN

SCALE 1"=30' DATE NOVEMBER, 2023


NO.	REVISION	DATE	BY

DESIGNED BY RA DRAWN BY NM CHECKED BY MWM

SHEET NO. 16 OF 20






PLOTTER: 11x17x24
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Tree Protection Fence Detail
Not to scale

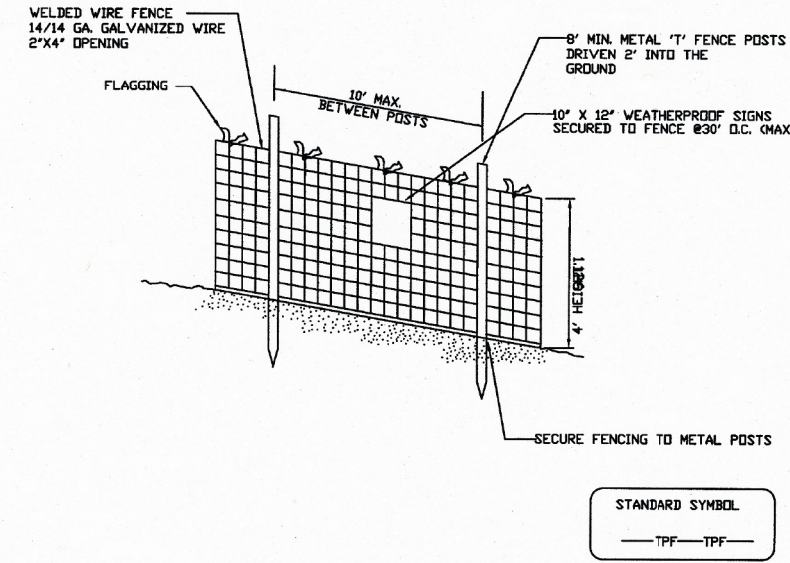

- NOTES**
1. Practice may be combined with sediment control fencing.
 2. Location and limits of fencing should be coordinated in field with arborist.
 3. Boundaries of protection area should be staked prior to installing protective device.
 4. Root damage should be avoided.
 5. Protection signage is required.
 6. Fencing shall be maintained throughout construction.

Montgomery County Planning Department • M-NCPPC
MontgomeryPlanning.org

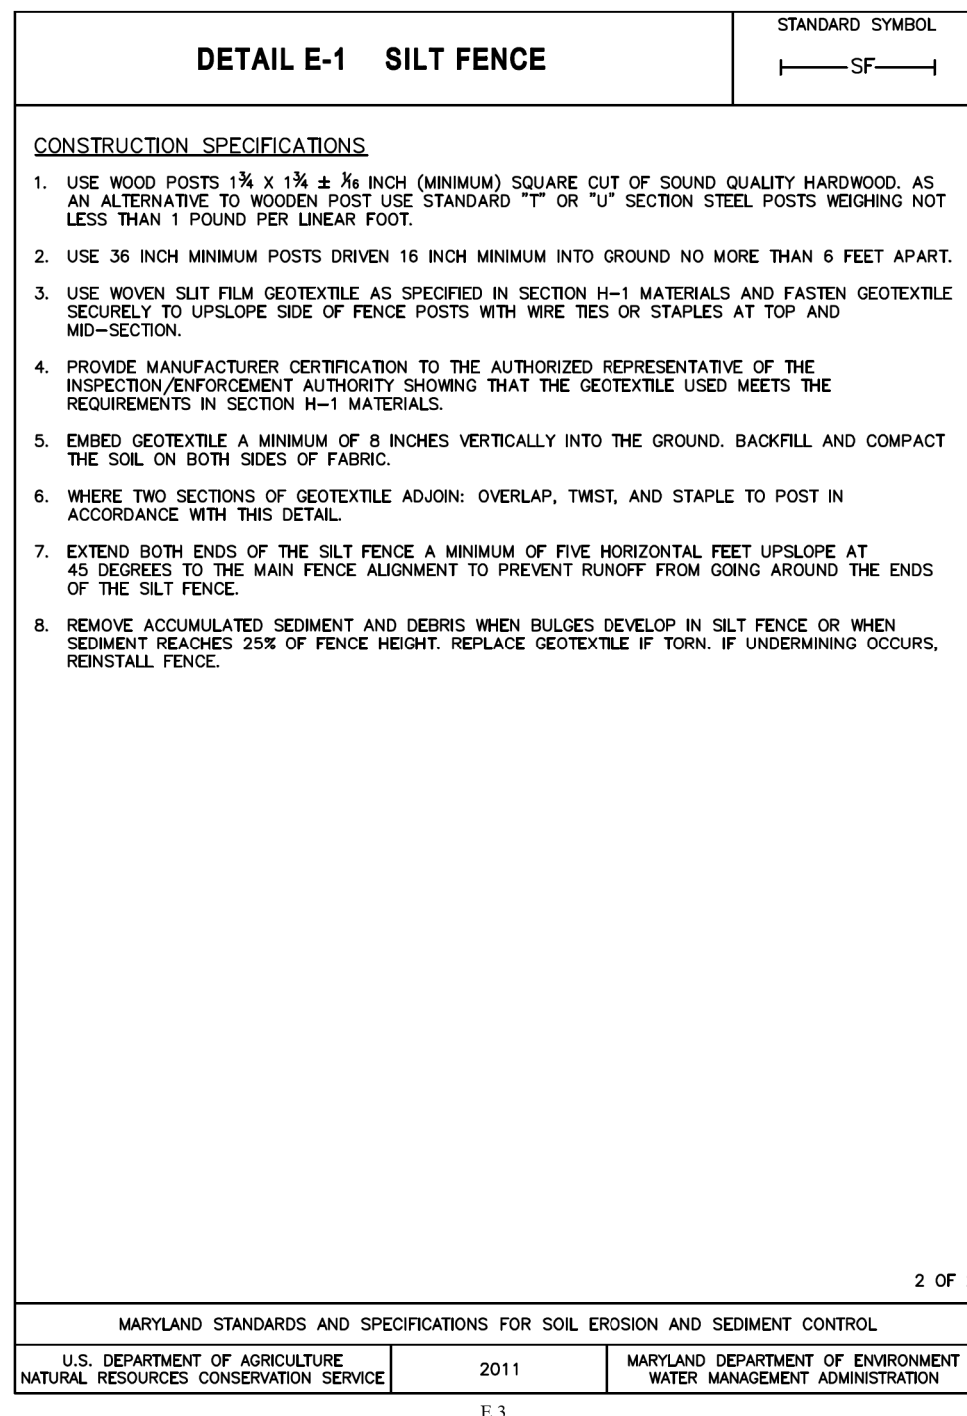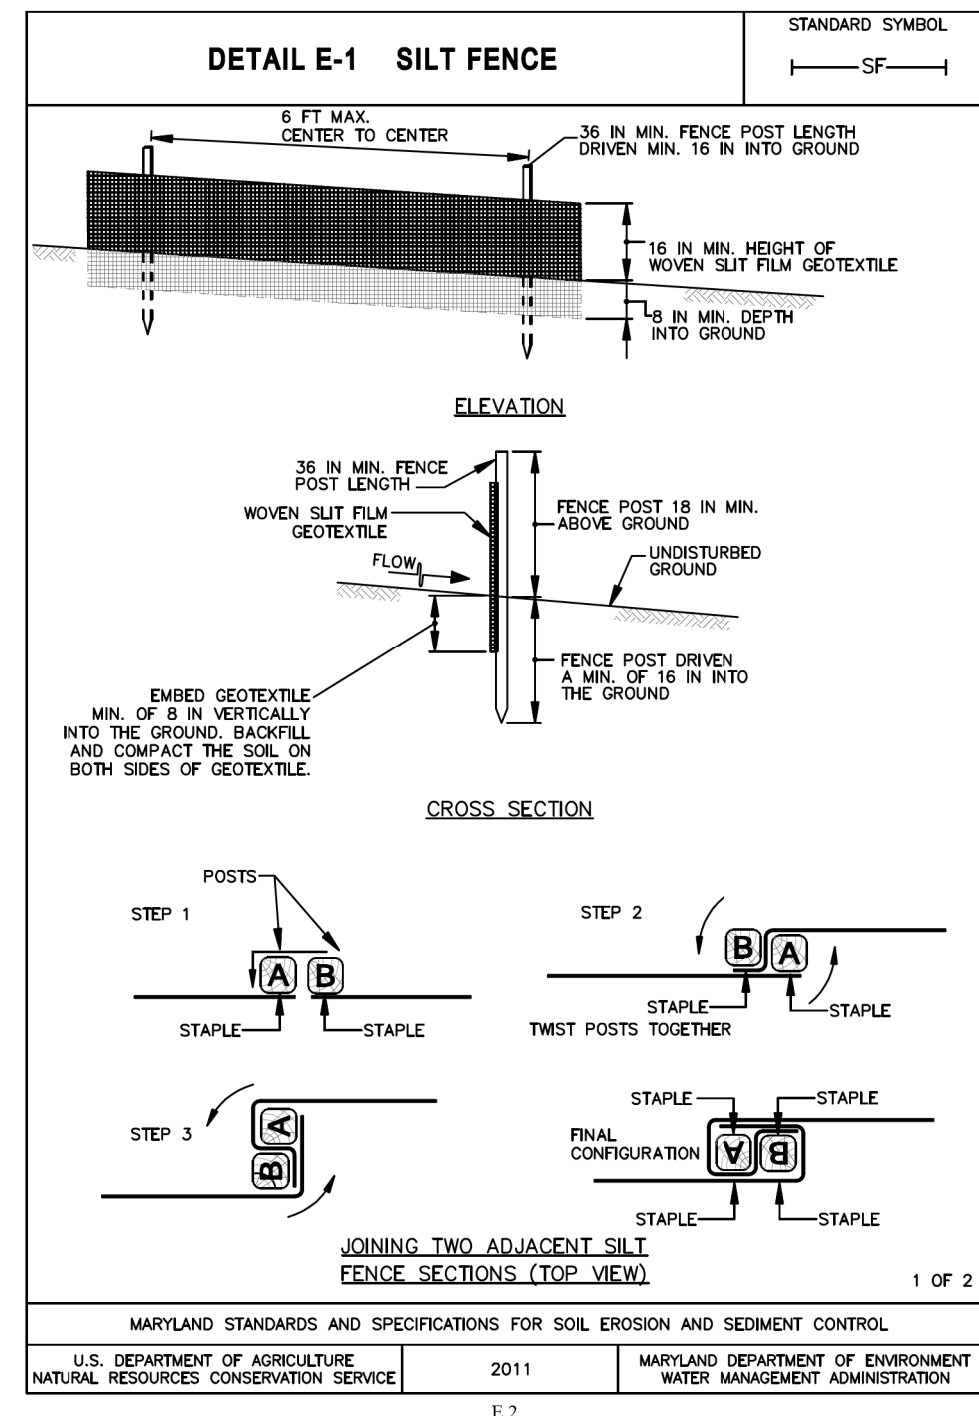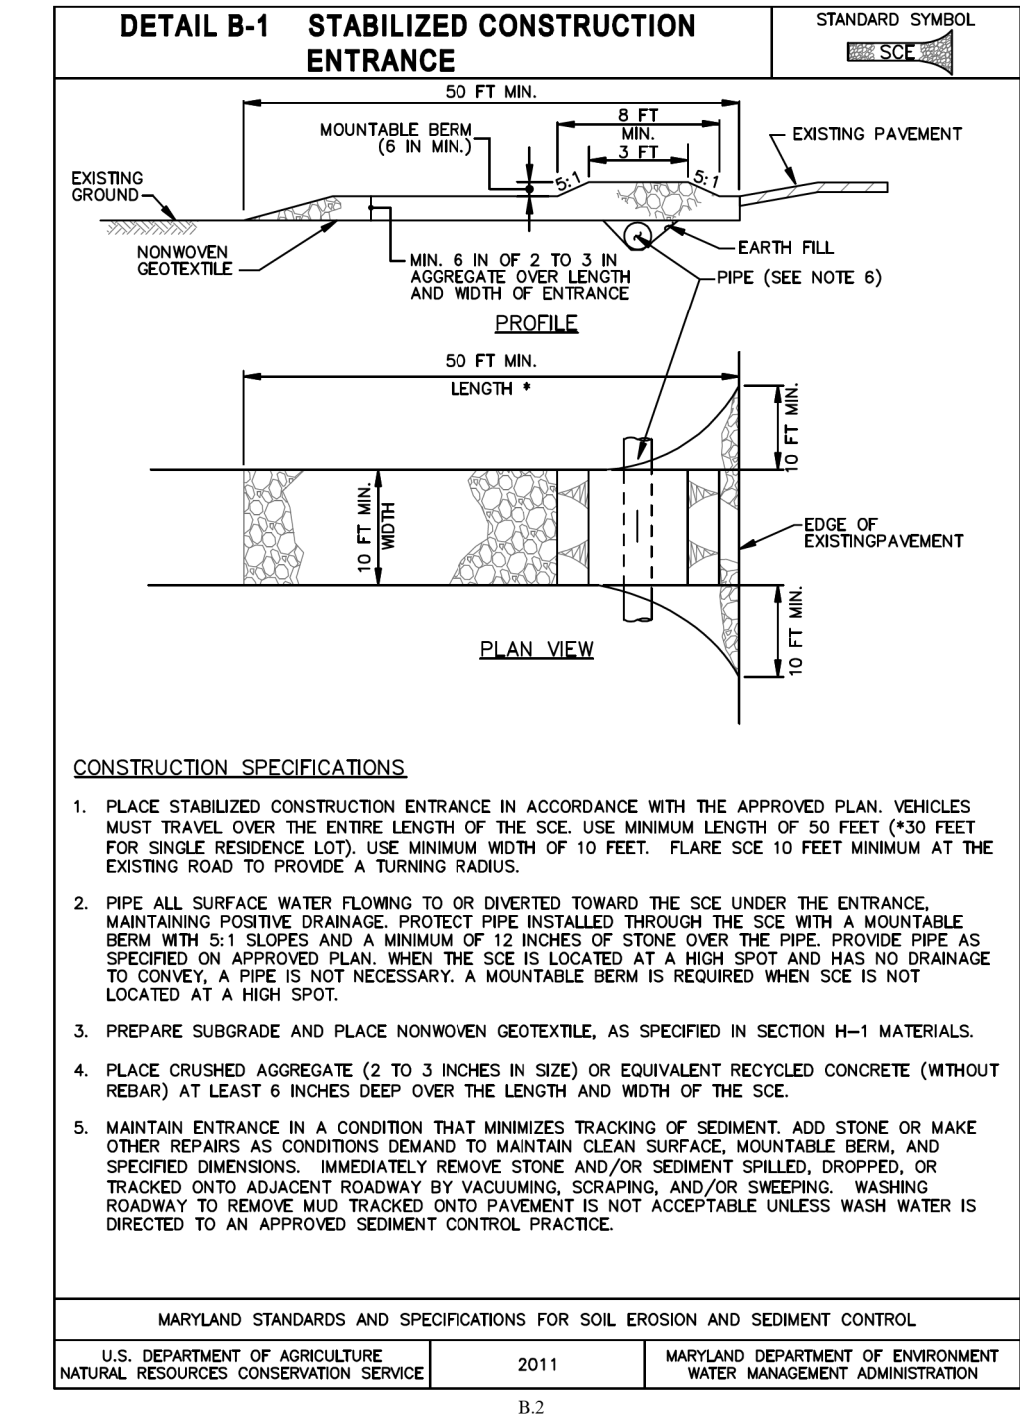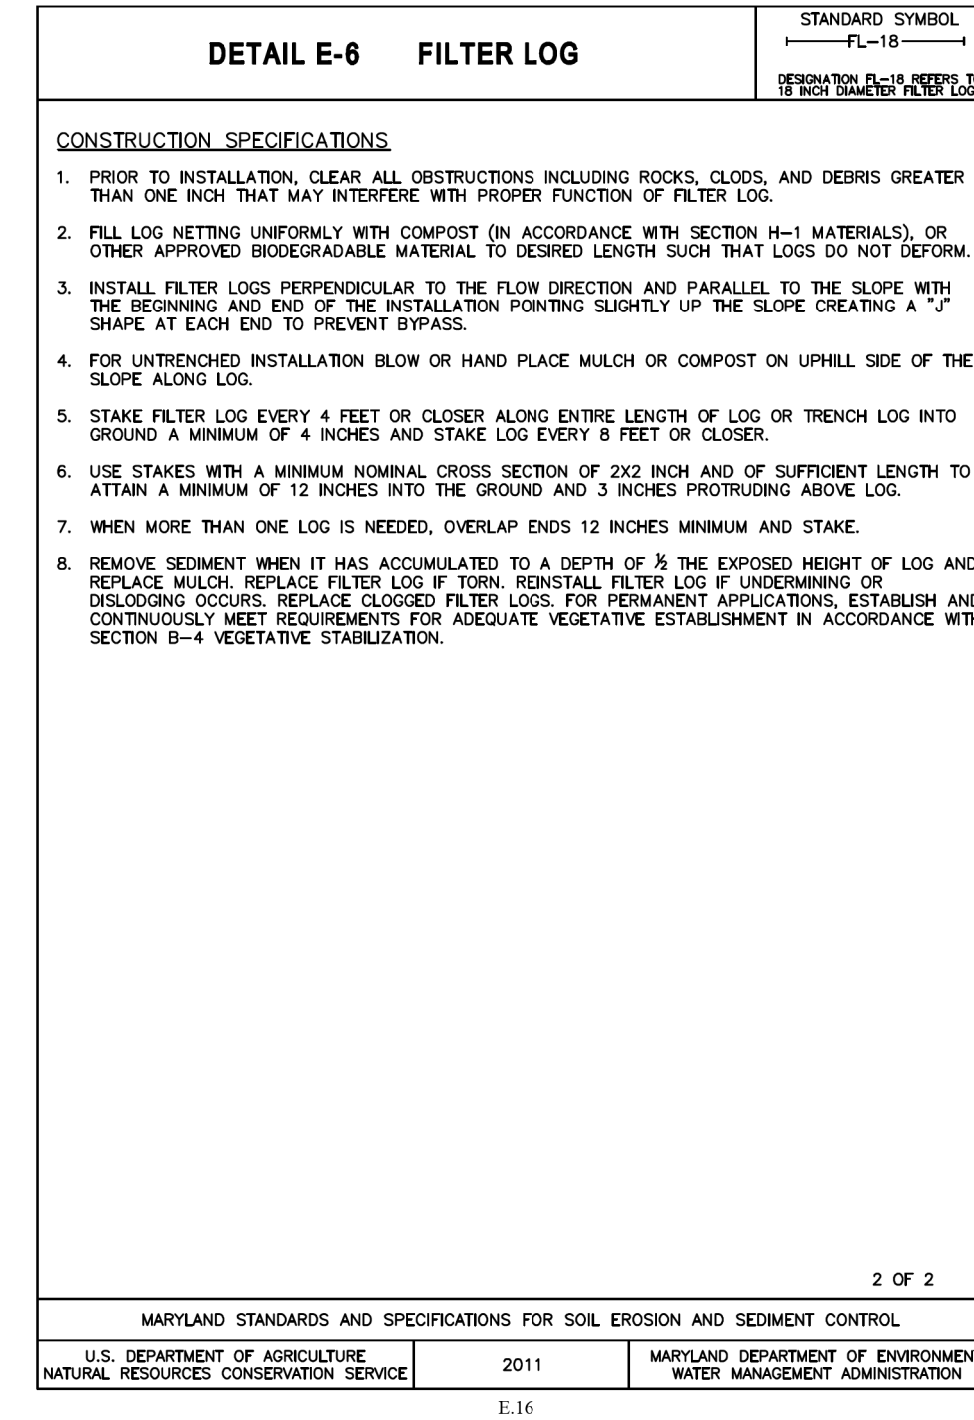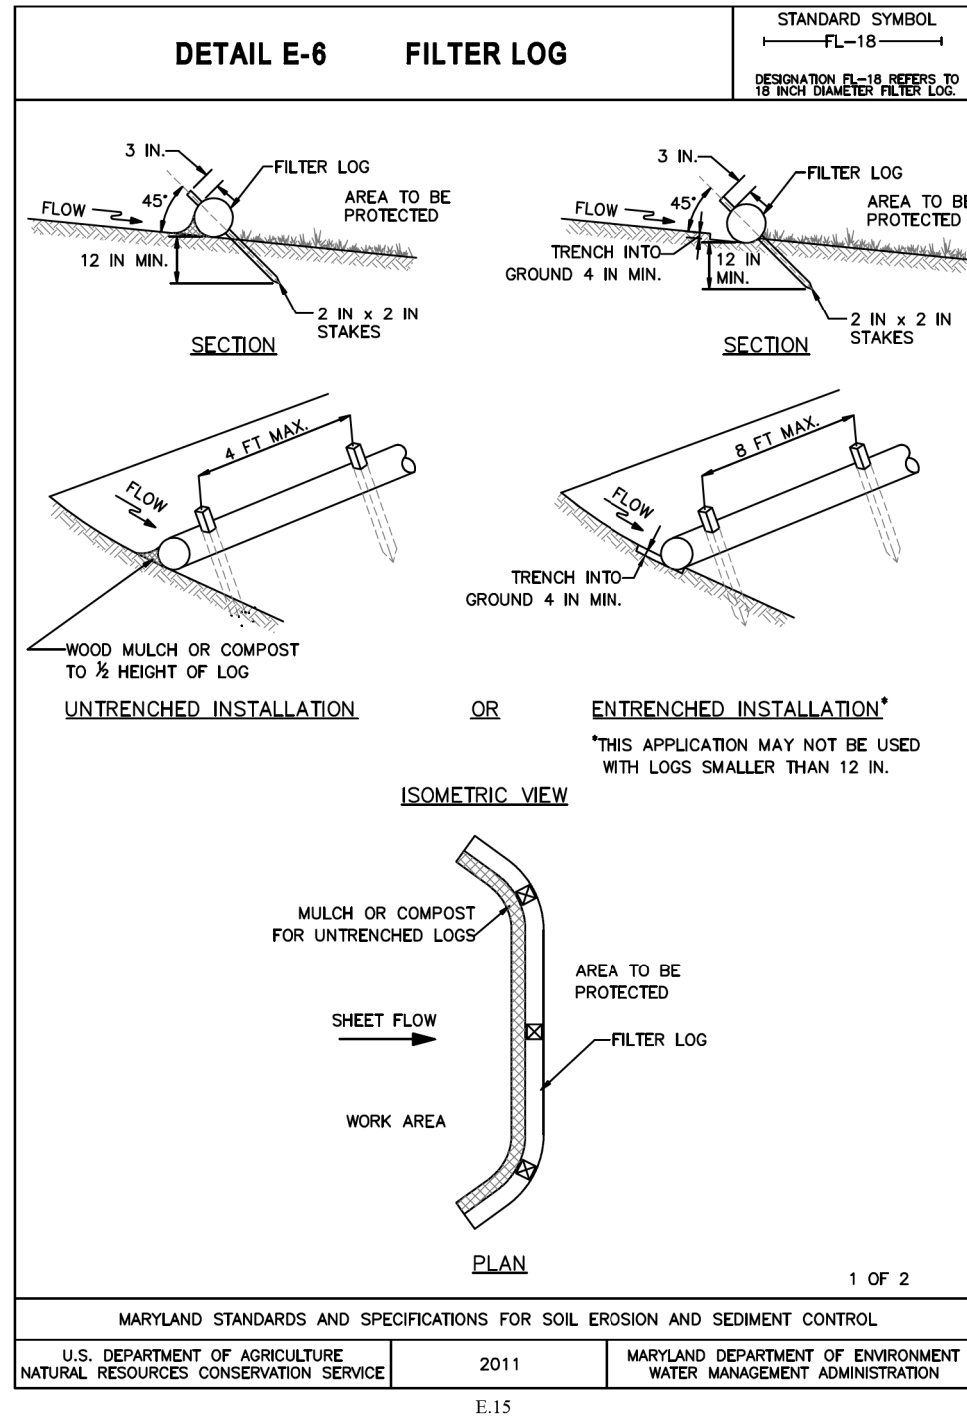

SC0008



MONTGOMERY COUNTY
DEPARTMENT OF TRANSPORTATION
ROCKVILLE, MARYLAND

MONTGOMERY COUNTY
DEPARTMENT OF TRANSPORTATION
DIVISION OF TRANSPORTATION ENGINEERING

NORWOOD ROAD SHARED USE PATH

EROSION AND SEDIMENT
STANDARD DETAILS

SCALE 1"=30' DATE NOVEMBER, 2023

SHEET NO. 17 OF 20

RECOMMENDED FOR APPROVAL

Chief, Transportation Planning and Design Section

Date




APPROVED

Chief, Division of Transportation Engineering

Date

DESIGNED BY RA DRAWN BY NM CHECKED BY MWM

NO. REVISION DATE BY

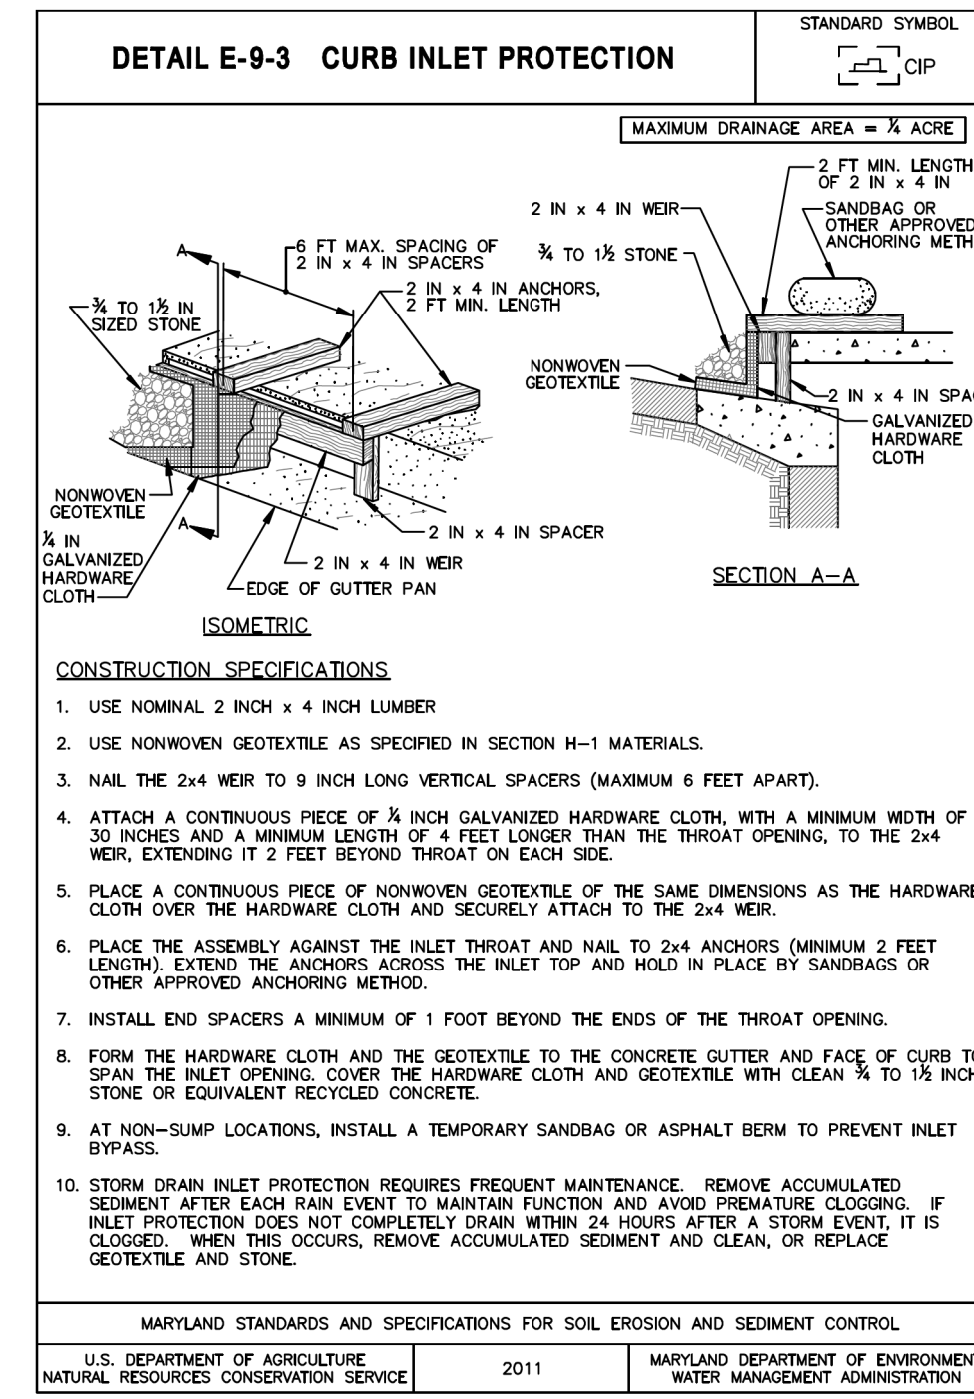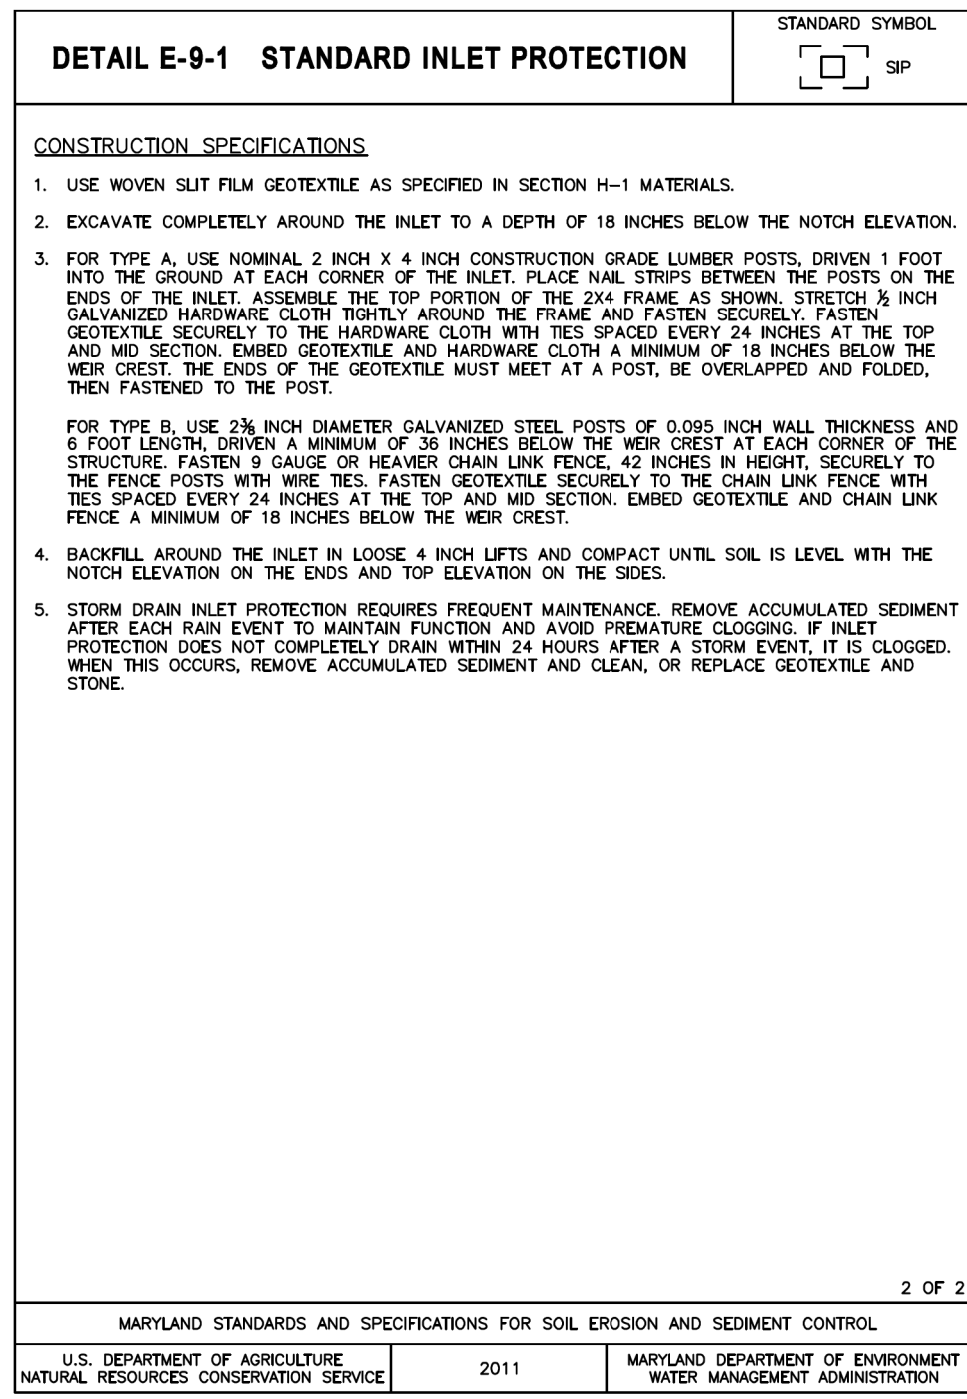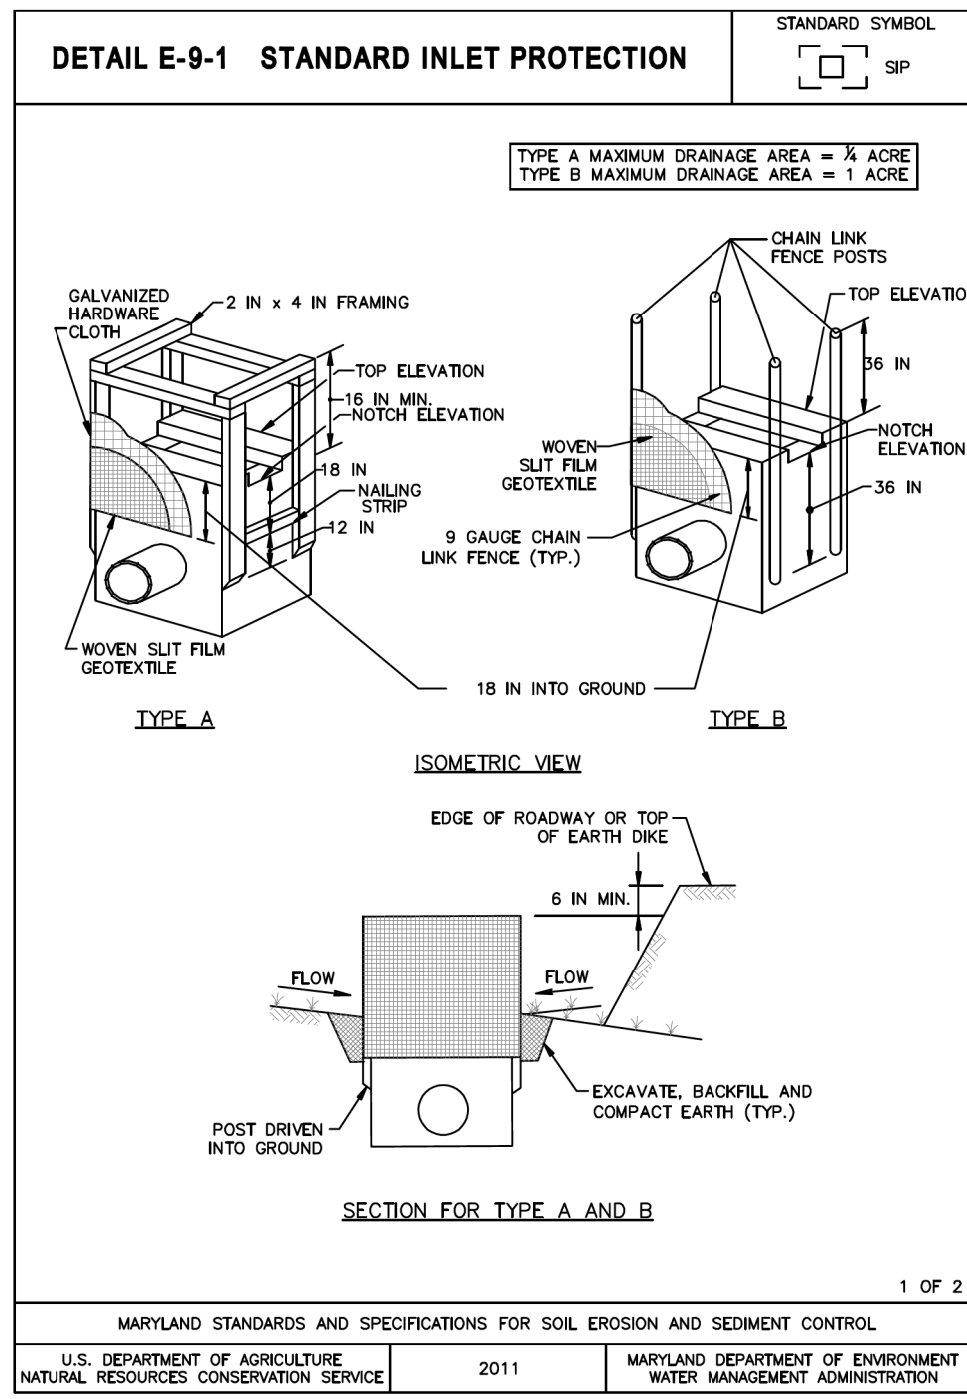

PLOTTER: 11x17.dwg
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MONTGOMERY COUNTY
DEPARTMENT OF TRANSPORTATION
ROCKVILLE, MARYLAND

RECOMMENDED FOR APPROVAL

Chief, Transportation Planning and Design Section

Date

APPROVED

Chief, Division of Transportation Engineering

Date

DESIGNED BY RA DRAWN BY NM CHECKED BY MWM

MONTGOMERY COUNTY
DEPARTMENT OF TRANSPORTATION
DIVISION OF TRANSPORTATION ENGINEERING
NORWOOD ROAD SHARED USE PATH

EROSION AND SEDIMENT
STANDARD DETAILS

SCALE 1"=30' DATE NOVEMBER, 2023

SHEET NO. 18 OF 20

SC0009

PROJECT DESCRIPTION

I. GENERAL

THIS PROJECT INVOLVES THE RECONSTRUCTION OF AN EXISTING TRAFFIC SIGNAL AT THE INTERSECTION OF MD 108 (OLNEY SANDY SPRING ROAD) AND NORWOOD ROAD IN MONTGOMERY COUNTY. THE MODIFICATIONS INCLUDE THE ADDITION OF APS PUSH BUTTONS, PEDESTRIAN SIGNAL HEADS, ADVANCED VIDEO DETECTION, AND THE TRANSFER OF SIGNAL HEADS FROM SPAN WIRE TO MAST ARM POLES. MD 108 IS ASSUMED TO RUN IN AN EAST-WEST DIRECTION.

II. INTERSECTION OPERATION

THE INTERSECTION IS TO OPERATE IN A NEMA 6-PHASE, FULLY-ACTUATED MODE, WITH THE MD 108 (OLNEY SANDY SPRING ROAD) APPROACHES OPERATING CONCURRENTLY AND THE NORWOOD ROAD APPROACH OPERATING SPLIT. PERMISSIVE LEFT TURN PHASING WILL BE PROVIDED FOR THE WESTBOUND MD 108 APPROACH. AN ALTERNATIVE PEDESTRIAN PHASE IS PROVIDED ALONG THE WEST LEG OF MD 108.

III. CONTROLLER REQUIREMENTS

INSTALL A FULLY-ACTUATED FOUR-PHASE CONTROLLER WITH THREE (3) FOUR CHANNEL, TIME-DELAY-OUTPUT LOOP DETECTOR AMPLIFIERS RACK MOUNT, INTERSECTION MONITOR WITH BATTERY BACK-UP FOR PHONE DROP, NIC MODULE, RACK DETECTOR SYSTEM, AND ASSOCIATED HARNESSES HOUSED IN A NEMA SIZE '5' BASE MOUNTED CABINET.

GENERAL NOTES

- FOR FINAL PAVEMENT MARKINGS, REFER TO THE PAVEMENT MARKING PLANS, AS APPLICABLE; OTHER THAN THOSE DETAILED ON THE PLAN. ALL PAVEMENT MARKINGS SHALL BE INSTALLED IN ACCORDANCE WITH ADMINISTRATION STANDARDS.
- THE CONTRACTOR SHALL BE RESPONSIBLE FOR TERMINATING ALL SIGNAL CABLE TO THE APPROPRIATE TERMINALS AND PROPERLY LABELING EACH CABLE.
- ALL TRAFFIC SIGNAL FOUNDATIONS SHALL BE INSTALLED AT THE FINAL SIDEWALK OR CURB GRADE FOR CLOSED SECTIONS, HIGHEST ROADWAY PROFILE GRADE FOR OPEN SECTIONS, TO MEET CLEARANCES AS SPECIFIED IN THE APPROPRIATE 800 SERIES STANDARD PLATES. THE CONTRACTOR SHALL VERIFY ULTIMATE GRADES PRIOR TO THE INSTALLATION OF ALL SIGNAL EQUIPMENT.
- FOR MONTGOMERY COUNTY PROJECTS, THE CONTRACTOR SHALL BE RESPONSIBLE FOR DELIVERING THE VIDEO INTERFACE EQUIPMENT TO THE MONTGOMERY COUNTY SIGNAL SHOP. COUNTY FORCES WILL COMPLETE THE RETROFIT WORK IN THE EXISTING CABINET.
- DISCONNECTING AND SPLICING OF INTERCONNECT CABLE SHALL BE PERFORMED BY ???? FORCES. THE CONTRACTOR SHALL RUN THE INTERCONNECT CABLE INTO THE BASE OF EACH CABINET AND PROPERLY TAG THE CABLE. CONTACT MR./MS. ??? AT (XXX) XXX-XXXX SEVENTY-TWO HOURS IN ADVANCE OF INTENDED WORK.
- ALL UNDERGROUND AND OVERHEAD UTILITIES SHOWN ON THESE PLANS ARE SCHEMATIC ONLY AND MAY NOT BE COMPLETE. THE CONTRACTOR SHALL BE RESPONSIBLE FOR NOTIFYING MISS UTILITY PRIOR TO CONSTRUCTION SO THAT ALL UTILITIES MAY BE LOCATED IN THE FIELD. IF THE CONTRACTOR PERCEIVES THAT A CONFLICT BETWEEN THE UTILITIES AND THE TRAFFIC SIGNAL WILL OCCUR, THE CONTRACTOR SHALL NOTIFY THE PROJECT ENGINEER IMMEDIATELY SO THAT THE CONFLICT MAY BE RESOLVED.
- FOR DEVELOPER JOBS, NOTE: CONTROLLER AND CABINET SHALL BE PURCHASED FROM ECONOLITE AND DELIVERED TO S.H.A. SIGNAL SHOP FOR WIRING AND TESTING A MINIMUM OF THREE (3) WEEKS PRIOR TO INSTALLATION. CONTACT MR. ED RODENHIZER (410) 787-7650 TO COORDINATE THIS EFFORT.
- THE CONTRACTOR SHALL MAINTAIN THE CONTINUOUS OPERATION OF ALL INTERCONNECT, VEHICULAR, PEDESTRIAN DETECTORS, AND LIGHTING DEVICES. IF ANY DEVICE IS DAMAGED BY THE CONTRACTOR, IT SHALL BE REPAIRED WITHIN 72 HOURS BY THE CONTRACTOR AT NO COST TO THE ADMINISTRATION AFTER NOTIFICATION BY THE ENGINEER.
- DURING CONSTRUCTION, PROPOSED SIGNAL EQUIPMENT SHALL NOT BLOCK EXISTING SIGNAL EQUIPMENT
- ALL UNUSED CABLE SHALL BE REMOVED AND DISPOSED OF BY THE CONTRACTOR

PROJECT CONTACT LIST

DISTRICT 3	OFFICE OF TRAFFIC AND SAFETY
VACANT ASSISTANT DISTRICT ENGINEER - TRAFFIC 301-513-7404	REBECCA LICHTENSTEIN, P.E. CHIEF, TRAFFIC OPERATIONS DIVISION 410-787-7630
MR. MARK LOEFFLER DISTRICT UTILITY ENGINEER 301-513-7350	MR. ANTOINE YATES ASSISTANT DIVISION CHIEF, TRAFFIC OPERATIONS DIVISIONS 410-787-7625
MR. GREGORY EDWARDS ASSISTANT DISTRICT ENGINEER - MAINTENANCE 301-513-7304	MR. MICHAEL BASSO SECTION CHIEF, SIGNAL OPERATIONS SECTION 410-787-7657
MS. AMY ANDREWS ASSISTANT DISTRICT ENGINEER - CONSTRUCTION (ADMIN.) 301-513-7300	MR. TODD JONES SIGN SHOP MANAGER 410-787-7676
VACANT ASSISTANT DISTRICT ENGINEER - CONSTRUCTION (FIELD) 301-513-7336	MR. MICHAEL BOYLE WAREHOUSE SECTION CHIEF 410-787-7673

EQUIPMENT LIST

EQUIPMENT LIST A.

ITEM NUMBER	QUANTITY	DESCRIPTION
2	EA	THREE-PHASE FULLY-ACTUATED CONTROLLER WITH VIDEO INTERFACE EQUIPMENT (1-3 CAMERAS), 3 FOUR-CHANNEL LOOP DETECTOR AMPLIFIERS AND INTERSECTION MONITOR HOUSED IN A NEMA SIZE 5 BASE MOUNTED CABINET
2	EA	SHEET ALUMINUM SIGNS TO CONSIST OF (POLE MOUNT) R10-3(1) SIGN (9 IN. X 15 IN) TO READ " PUSH BUTTON TO CROSS SANDY SPRING ROAD"
2	EA	R10-3(1) SIGN (9 IN. X 15 IN) TO READ " PUSH BUTTON TO CROSS NORWOOD ROAD"
1	EA	M1-5(1) SIGN (78 IN. X 36 IN) - MAST ARM MOUNT
2	EA	R10-11b(1) SIGN (36 IN. X 36 IN) - MAST ARM MOUNT
2	EA	D-3(2) SIGN (VAR. X 16 IN) - MAST ARM MOUNT
1	EA	D-3(1) SIGN (VAR. X 16 IN) - MAST ARM MOUNT

EQUIPMENT LIST B.

ITEM NUMBER	QUANTITY	DESCRIPTION
120500	1	MAINTENANCE OF TRAFFIC
801004	11	CONCRETE FOR SIGNAL FOUNDATION
114280	135	REMOVAL OF EXISTING PERMANENT PAVEMENT MARKING LINES
549617	202	24 INCH WHITE PREFORMED THERMOPLASTIC PAVEMENT MARKING LINES
549603	714	5 INCH YELLOW PREFORMED THERMOPLASTIC PAVEMENT MARKING LINES
860284	21	12 INCH LED VEHICULAR TRAFFIC SIGNAL HEAD SECTION
865300	1	2-WIRE APS CENTRAL CONTROL UNIT
865210	4	AUDIBLE/TACTILE PEDESTRIAN PUSHBUTTON STATION & SIGNS
818004	4	10 FOOT BREAKAWAY PEDESTAL POLE
807500	1	EMBEDDED METERED SERVICE PEDESTAL
816105	1	TRAFFIC SIGNAL CABINET NEMA SIZE 5
860285	4	16 INCH LED COUNTDOWN PEDESTRIAN SIGNAL HEAD
873003	1	REMOVE AND DISPOSE OF EXISTING SIGNAL EQUIPMENT (PER SIGNALIZED INTERSECTION LOCATION)
818162	1	MAST ARM POLE AND 50' MAST ARM, ANY 'T' DIMENSION, FOUNDATION AND GROUND ROD
818164	1	MAST ARM POLE AND 60' MAST ARM, ANY 'T' DIMENSION, FOUNDATION AND GROUND ROD
816010	3	VIDEO DETECTION CAMERA TO CONTROLLER & CABLE UP TO 500 FT
805118	258	4 INCH SCHEDULE 80 RIGID PVC CONDUIT - BORED
805125	149	2 INCH SCHEDULE 80 RIGID PVC CONDUIT - TRENCHED
805135	31	3 INCH SCHEDULE 80 RIGID PVC CONDUIT - TRENCHED
805140	119	4 INCH SCHEDULE 80 RIGID PVC CONDUIT - TRENCHED
801616	29	INSTALL OVERHEAD OR GROUND MOUNTED SIGN (INCLUDING ALL HARDWARE)
802501	557	NO. 6 AWG STRANDED BARE COPPER GROUND WIRE
861105	377	ELECTRICAL CABLE - 2 CONDUCTOR (NO. 14 AWG)
861107	891	ELECTRICAL CABLE - 5 CONDUCTOR (NO. 14 AWG)
861108	508	ELECTRICAL CABLE - 7 CONDUCTOR (NO. 14 AWG)
803013	1	FURNISH AND INSTALL SIGN/LUMINAIRE SUPPORTS
837001	6	GROUND ROD - 3/8 INCH DIAMETER X 10 FOOT LENGTH

EQUIPMENT LIST C.

ITEM NUMBER	QUANTITY	DESCRIPTION
		EQUIPMENT TO BE SALVAGED AND RETURNED TO SHA
		ALL REMOVED MATERIALS ARE TO BECOME THE PROPERTY OF THE CONTRACTOR

MAINTENANCE OF TRAFFIC NOTE


MAINTENANCE OF TRAFFIC WILL BE HANDLED BY THE CONTRACTOR UTILIZING THE FOLLOWING STANDARD PLATES FOR TRAFFIC CONTROL:
 STANDARD NO. 104.03-01 (MULTI-LANE UNDIVIDED SHOULDER WORK)
 STANDARD NO. 104.04-01 (MULTI-LANE DIVIDED SHOULDER WORK)
 ADDITIONAL TRAFFIC CONTROL STANDARDS MAY BE USED AS DIRECTED BY THE ENGINEER.

PHASE CHART

	1	2	3	4	5	6	7	8	9	10	11
PHASE 2 AND 6	R	R	G	G	G	G	G	DW	DW	WK	WK
PED CLEARANCE	R	R	G	G	G	G	G	DW	DW	FL/DW	FL/DW
2 AND 6 CHANGE	R	R	Y	Y	Y	Y	Y	DW	DW	DW	DW
PHASE 4	G	G	R	R	R	R	R	WK	WK	DW	DW
PED CLEARANCE	G	G	R	R	R	R	R	FL/DW	FL/DW	DW	DW
4 CHANGE	Y	Y	R	R	R	R	R	DW	DW	DW	DW
FLASHING OPERATION	FL/R	FL/R	FL/Y	FL/Y	FL/Y	FL/Y	FL/Y	DARK	DARK	DARK	DARK

WIRING DIAGRAM

NOT TO SCALE

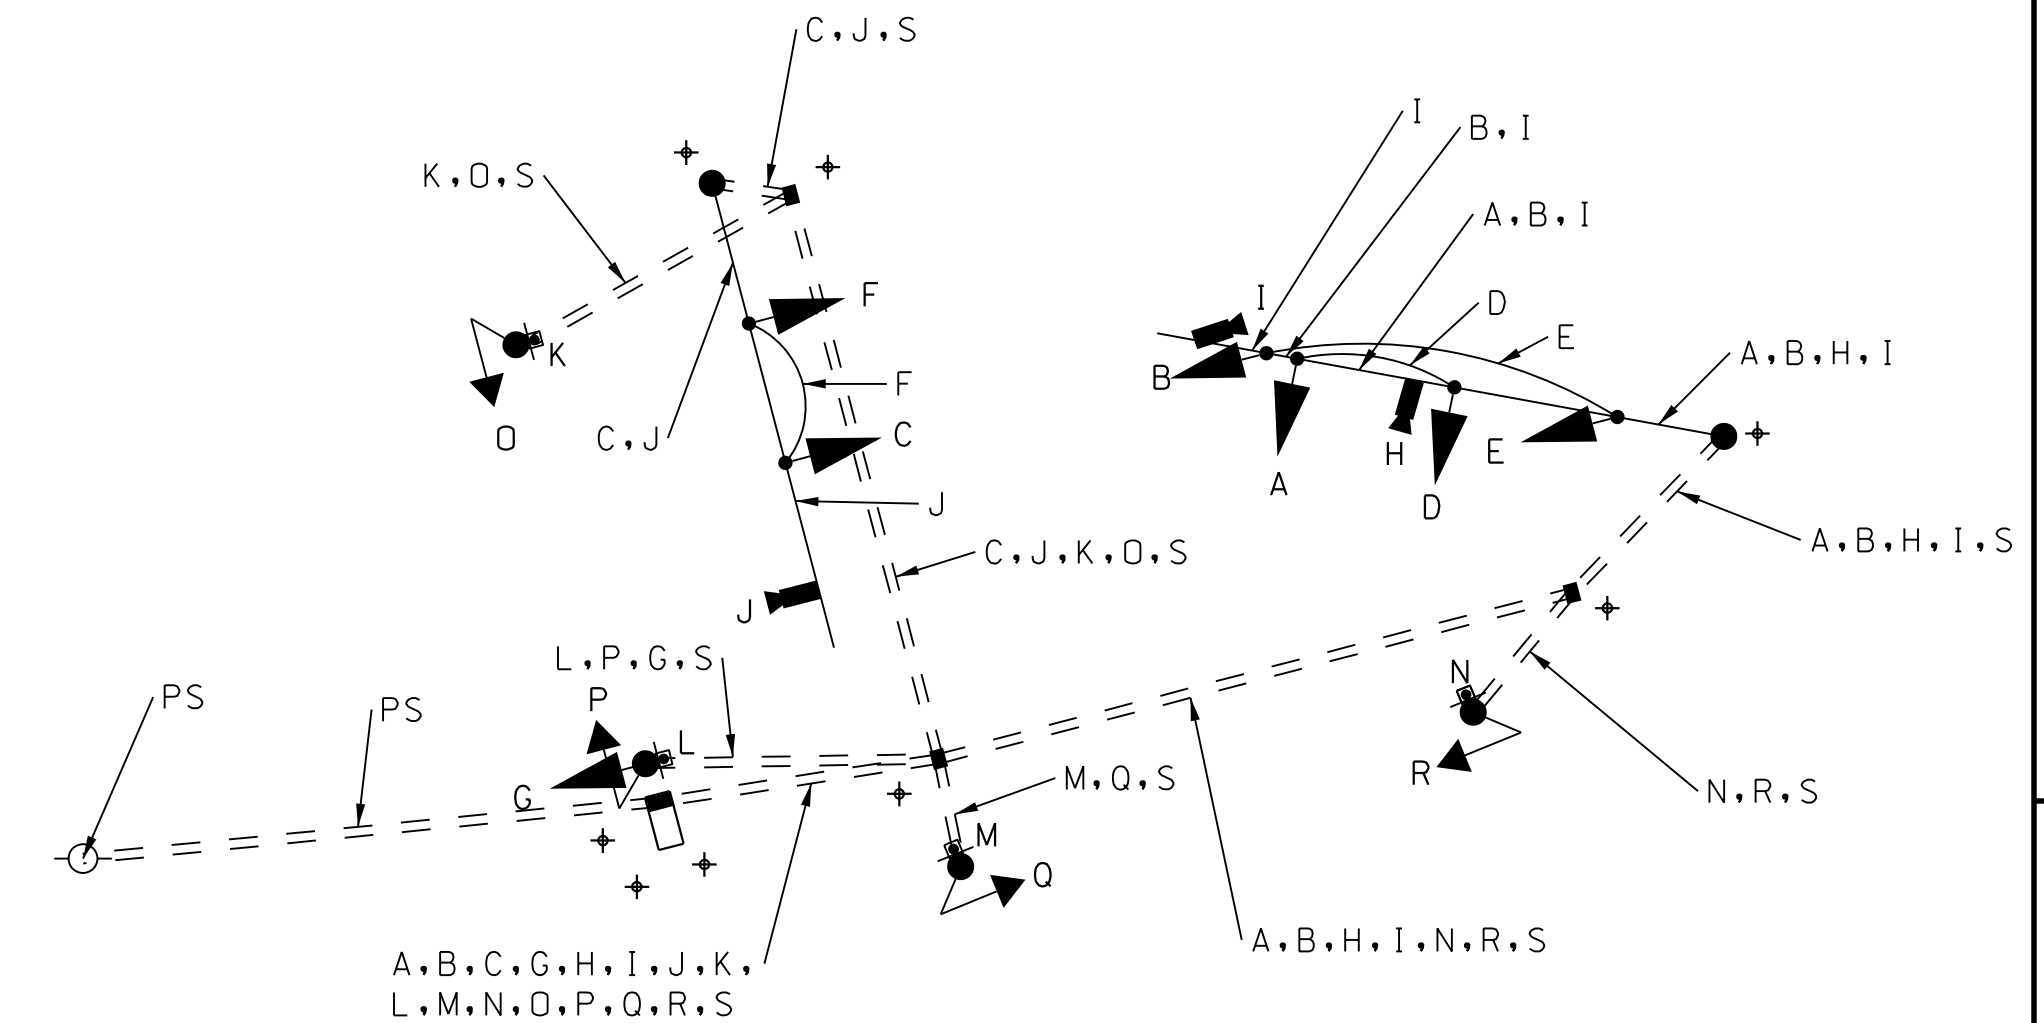

WIRING KEY

A, B, C, D, E, F, G	7 CONDUCTOR ELECTRICAL CABLE (NO. 14 AWG)	O, P, Q, R	5 CONDUCTOR ELECTRICAL CABLE (NO. 14 AWG) PEDESTRIAN SIGNAL HEADS
H, I, J, K, L, M, N	5 CONDUCTOR ELECTRICAL CABLE (NO. 14 AWG)	S	#6 AWG GROUND WIRE
	IP-BASED VIDEO DETECTION CABLE (3/C #18)	+	GROUND ROD
	2 CONDUCTOR ELECTRICAL CABLE (NO. 14 AWG) APS PUSHBUTTONS		

MDOT
 MARYLAND DEPARTMENT OF TRANSPORTATION
 STATE HIGHWAY ADMINISTRATION

SANDY SPRING BIKEWAY FACILITY PLANNING
 MD 108 (OLNEY SANDY SPRING ROAD)
 AT NORWOOD ROAD TRAFFIC SIGNAL

GENERAL INFORMATION SHEET

SCALE	N.T.S.	ADVERTISED DATE	CONTRACT NO.	<CONTRACT NO.>
DESIGNED BY	CB	COUNTY	MONTGOMERY	
DRAWN BY	CB	LOGMILE	<LOGMILE.>	
CHECKED BY	MJ		<TIMS NO.>	
MDE/PRD	<00-AA-0000>		<TOD NO.>	
<TS NO.>	XX 1	1	SHEET NO. 19 OF 20	

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TOOLE DESIGN

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